


JHS 14 NAPLES LLC SCREEN ENCLOSURE

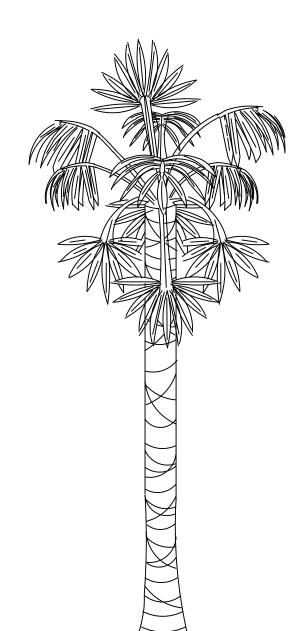


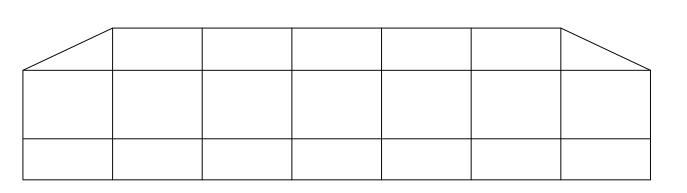

DF	RAWING INDEX
SHEET#	SHEET DESCRIPTION
CS-1	COVER SHEET
A-1	DESIGN PARAMETERS
A-3	ROOF PLAN
A-4	ELEVATIONS
A-5	DETAILS PLAN
A-6	DETAILS PLAN

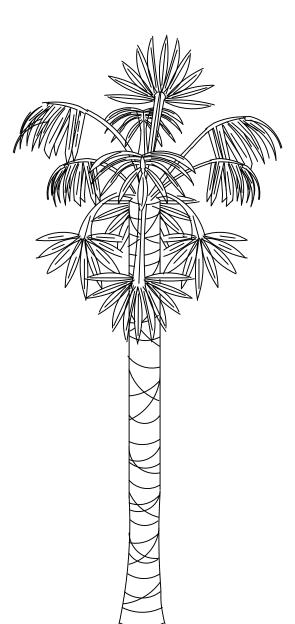

ENCO GROUP INC

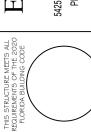


JHS 14 NAPLES LLC SCREEN ENCLOSURE 94 29TH ST SW NAPLES, FLORIDA,34117

REVISIONS			
ЛK	DATE	DESCRIPTION	
OF	3 NO.	21135E	

JOB NO: 21135E DATE: 04/16/21 DRAWN BY: L. CARDONA CHK'D BY: A. PANQUEVA

SHEET NUMBER

CS-1

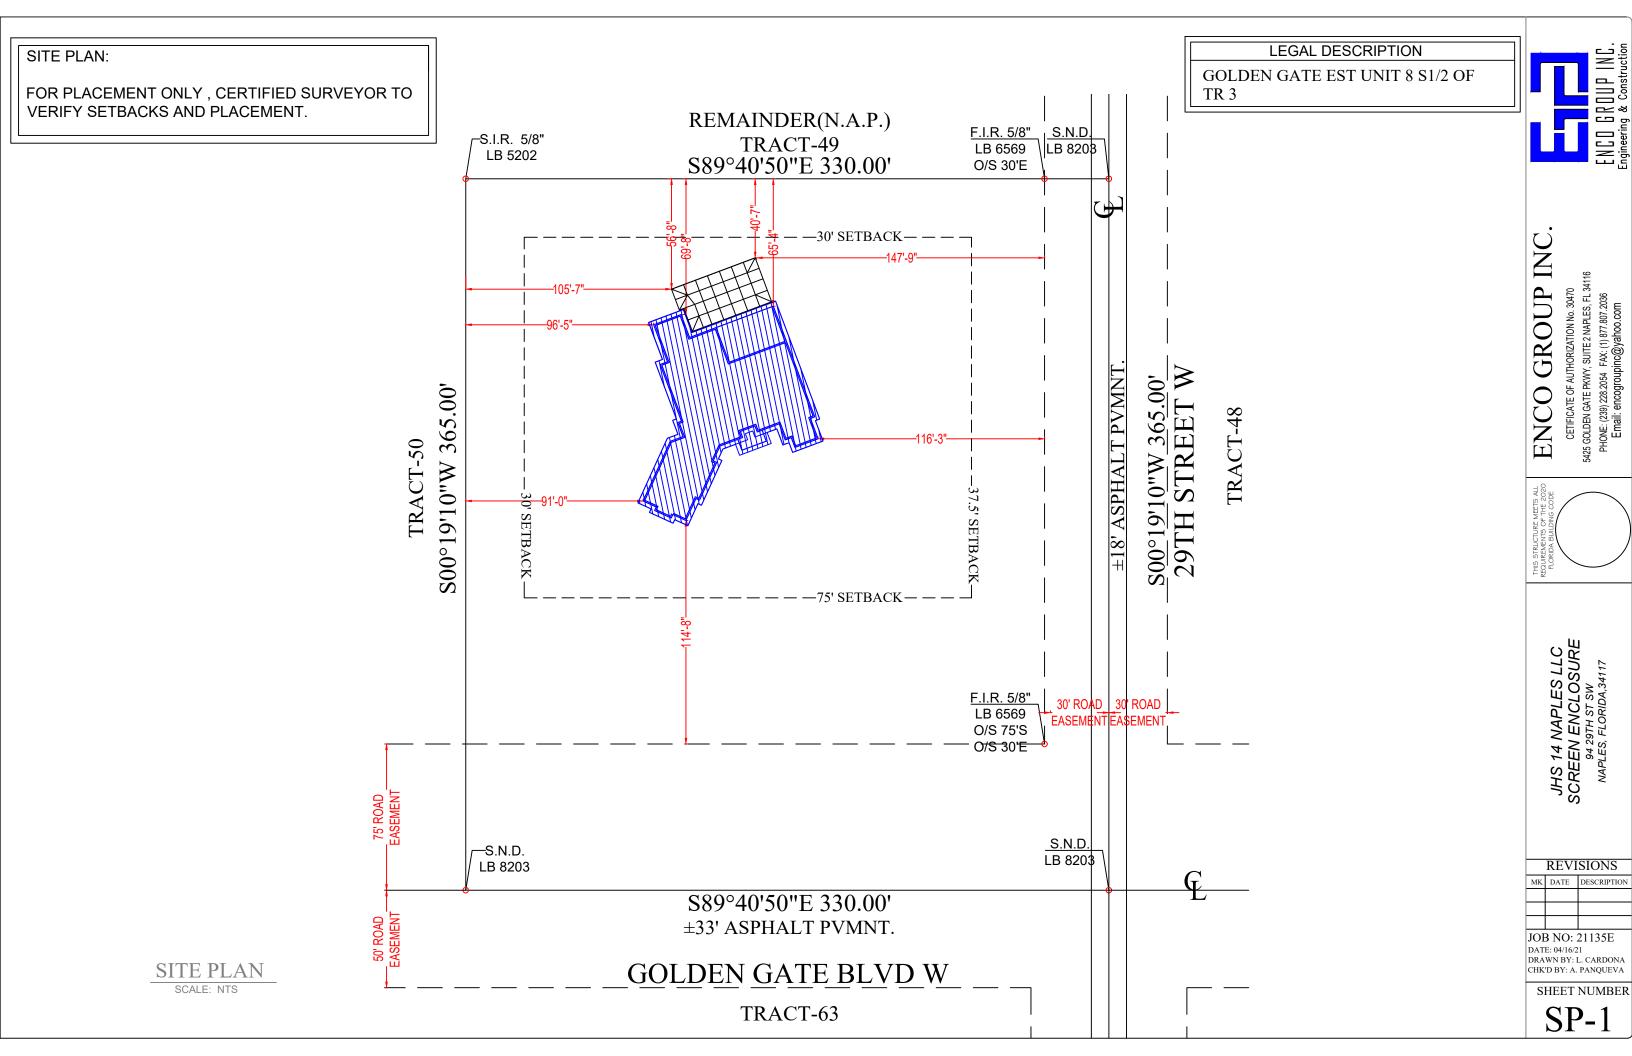

FOUNDATION NOTES:

- 1.) FOR MISSED REBAR DRILL AN 8 INCH x 3/4 INCH HOLE IN CONCRETE . CLEAN HOLE FREE OF ALL DUST AND DEBRIS. FILL WITH EPOXY, THEN INSERT NO. 5 BAR WITH A MINIMUM 25" INCH LAP.
- 2.) FOR MISSED J-BOLT DRILL 5/8" INCH HOLE x DEPTH OF APPROPRIATE ANCHOR. CLEAN HOLE FREE OF ALL DUST AND DEBRIS. INSERT 5/8" X 5" REDHEADS UNLESS NOTED OTHERWISE ON PLANS.
- 3.) FOOTING DOWEL BARS SHALL BE PROVIDED FOR ALL REQUIRED REINFORCEMENT IN THE FOLLOWING LOCATIONS.
 - A.) AT ALL CORNERS
 - B.) AT EACH SIDE OF OPENINGS OVER 6 FEET.
 - C.) AT ALL OTHER REINFORCING LOCATIONS (AS NOTED ON PLANS).
 - D.) AT ALL GIRDER BEARING LOCATIONS.
 - E.) AT 4 FEET ON CENTER MAXIMUM.
- 4.) CONTRACTOR AND OR SUB-CONTRACTOR SHALL REVIEW THE TRUSS PLACEMENT PLANS AND CONSTRUCTION PLANS TO COORDINATE PLACEMENT OF FOOTINGS, DOWELS AND VERTICAL REINFORCEMENT PRIOR TO ANY CONCRETE POUR.
- 5.) ISOLATED PADS TO HAVE A 12 INCHES MINIMUM COVER OVER CONCRETE.
- 6.) ALL FOUNDATIONS TO HAVE DOWEL RODS OR EMBEDDED RODS PER ARCHITECTURAL OR STRUCTURAL PLANS.
- 7.) BARS TO BE EVEN AND UNIFORMLY SPACED BASED ON MINIMUM COVER REQUIREMENTS.
- 8.) PAD FOOTING STEEL TO BE INDEPENDENT OF OTHER REINFORCING.
- 9.) EDGE OF SLAB TO BE RECESSED FOR GARAGE DOORS, EXTERIOR DOORS AND SLIDING GLASS DOORS AS NOTED ON PLANS.
- 10. CONCRETE SHALL HAVE A MINIMUM COMPRESSIVE STRENGTH OF 3000 PSI AT 28 DAYS, UNLESS NOTED OTHERWISE.
- 11. FILL UNDER CONCRETE SLABS SHALL BE CLEAN AND FREE FROM DEBRIS AND OTHER DELETERIOUS MATERIAL. FILL SHALL BE COMPACTED TO A DENSITY OF AT LEAST 95% OF STANDARD PROCTOR MAXIMUM DRY DENSITY (ASTM D1557).
- 12. FOOTINGS SHALL BEAR UPON UNDISTURBED SOLID SOIL OR UPON SOIL COMPACTED TO A DENSITY OF AT LEAST 95% OF STANDARD PROCTOR MAXIMUM DRY DENSITY (ASTM D1557) FOR A DEPTH OF AT LEAST THREE FEET BELOW THE BASE OF
- 13. WHERE SHOWN, CORES OF BLOCK MASONARY SHALL BE FILLED WITH GROUT OR PEA GRAVEL CONCRETE WITH A MIN. COMPRESSIVE STRENGTH OF 3000 PSI AT 28 DAYS.
- 14. REINFORCING STEEL SHALL BE NO. 5 OR NO. 4 BARS. ASTM A-615 GRADE 60 DEFORMED NEW BILLET STEEL CONFORMING TO ACI 301, CAI, 315, ACI, 318, AND CRSI MANUAL OF STANDARD PRACTICE, LATEST EDITIONS.
- 15. (R606.9.2 SPLICING. SPLICES SHALL BE LAP SLPICES. NON-CONTACT LAP SPLICES SHALL BE PERMITTED PROVIDED REINFORCING BARS ARE NOT SPACED FARTHER APART THAN 5 INCHES. SPLICE LENGHTS SHALL BE IN ACCORDANCE WITH TABLE R606.9.2. AND SHALL BE A MINIMUM OF 25 INCHES FOR NO. 5 BARS AND 20 INCHES FOR NO. 4 BARS.
- 16. CONCRETE COVER OF REINFORCING STEEL SHALL BE AS FOLLOWS:
- A. FOOTINGS: 3" BOTT. AND SIDES, 2" TOP
- B. BEAM: 1.5" BOTT. SIDES AND TOP
- C. COLUMNS 1.25"
- D. SLABS ON GRADE: 3" BOTT. 1" TOP
- 17. (R606.9.1 BUNDLING. BUNDLING SHALL BE PERMITTED WHEN TWO BARS ARE REQUIRED AT THE SAME LOCATION IN A WALL OR IN A BOND BEAM
- 18. (R606.9.9.1) OFFSET REINFORCEMENT. VERTICAL REINFORCEMENT SHALL BE PERMITTED TO BE OFFSET BETWEEN FLOOR LEVELS. REINFORCEMENT FOR THE LOWER STORY SHALL BE ANCHORED INTO THE UPPER FLOOR LEVEL BOND BEAM AND REINFORCEMENT FOR THE UPPER STORY SHALL BR ANCHORED INTO THE BOND BEAMS ABOVE AND BELOW IN ACCORDANCE WITH SECTION R606.9.8 AND FIGURES R606.9A AND R606.9B
- 19. (R606.9.10 METAL ACCESSORIES. JOINT REINFORCEMENT, ANCHORS, TIES AND WIRE FABRIC SHALL CONFORM TO THE FOLLOWING: ASTM A 82 FOR WIRE ANCHORS AND TIES; ASTM A 36 FOR PLATE, HEADED AND BENT-BAR ANCHORS; ASTM A 510 FOR CORRUGATED SHEET METAL ANCHORS AND TIES; ASTM A 951 FOR JOINT REINFORCEMENT; ASTM B 227 FOR COPPER-CLAD STEEL WIRE TIES; OR ASTM A 167 FOR STAIN-LESS STEEL HARDWARE.

SINGLE FAMILY RESIDENCES, DUPLEX AND TOWNHOUSES LESS THAN FOUR STORIES IN ELEVATION MUST HAVE AT LEAST ONE OF THE FOLLOWING POOL SAFETY FEATURES: TO COMPLY WITH SECTION R4501.17.1.1 THROUGH R4501.17.1.14 OF THE 2020 FBC.

SCOPE OF WORK	
SCREEN ENCLOSURE	Ī

NOTE

IT IS THE RESPONSIBILITY OF THE GENERAL CONTRACTOR TO REVIEW AND CONFIRM THE DESIGN OF THIS STRUCTURE VERIFING DIMENSIONS AND DETAILS THAT CONTRIBUTE TO OWNER SPECIFICATION ANY DISCREPANCIES ARE TO BE RELAYED TO DRAFTSMAN PRIOR TO ANY WORK BEING STARTED FAILURE TO DO SO GENERAL CONTRACTOR ASSUMES TOTAL RESPONSIBILITY

GENERAL NOTES:

- 1. IT IS THE INTENT OF THE DESIGNER THAT THIS WORK BE IN CONFORMANCE WITH ALL REQUIREMENTS OF THE BUILDING AUTHORITIES HAVING JURISDICTION OVER THIS TYPE OF CONSTRUCTION AND OCCUPANCY. ALL CONTRACTORS SHALL DO THEIR WORK IN CONFORMANCE WITH ALL APPLICABLE CODES AND REGULATIONS.
- 2. CONTRACTOR TO VERIFY ALL DIMENSIONS PRIOR TO CONSTRUCTION WRITTEN DIMENSIONS TO TAKE PRECEDENCE OVER SCALED DIMENSIONS.
- 3.) MASONRY CONTRACTOR TO VERIFY MASONRY OPENIG DIMENSIONS FOR ALL WINDOWS, SLIDING GLASS DOORS, & ENTRY DOORS, AS SHOWN ON THE PLAN, WITH DOOR AND WINDOW MANUFACTURER.
- 4.) IT IS THE CONTRACTOR'S RESPONSIBILITY TO CHECK THESE PLANS FOR DIMENSIONAL ERRORS, AND/OR OMISSIONS PRIOR TO CONSTRUCTION. IF ANY ERRORS OR OMISSIONS EXIST IN THE DRAWINGS AND SPECIFICATIONS, THE CONTRACTOR SHALL NOTIFY THE DESIGNER, IN WRITING, WITHIN 10 DAYS OF RECEIPT OF PLANS, AND PRIOR TO ANY CONSTRUCTION, OR CONTRACTOR ASSUMES THE RESPONSIBILITY FOR THE RESULTS AND ALL COSTS OF RECTIFYNG SAME.
- 5. THE CONTRACTOR SHALL SUPPLY, LOCATE, AND BUILD INTO THE WORK ALL INSERTS, ANCHORS, ANGLES, PLATES, OPENINGS, SLEEVES, HANGERS, SLAB DEPRESSIONS, AND PITCHES AS MAY BE REQUIRED TO ATTACH AND ACCOMMODATE OTHER WORK.
- 6. ALL DETAILS AND SECTIONS SHOWN ON THE DRAWINGS ARE INTENDED TO BE TYPICAL AND SHALL BE CONSTRUED TO APPLY TO ANY SIMILAR SITUATION ELSEWHERE IN THE WORK EXCEPT WHERE A DIFFERENT DETAIL IS SHOWN.

	DESIGN PARAMETERS		
APPLICABLE CODES: BUILDING CODE= FLORIDA BUILDING CODE (2020) MECHANICAL CODE= FLORIDA BUILDING CODE (2020) PLUMBING CODE= FLORIDA BUILDING CODE (2020) ELECTRICAL CODE= N.E.C. 2017 LIFE SAFETY CODE= 6TH EDITION FIRE PREVENTION CODE ACCESSIBILITY CODE= FLORIDA BUILDING CODE (2020) ENERGY CODE= FLORIDA BUILDING CODE (2020)		BUILDING CONSTRUCTION TYPE: TYPE I TYPE IV TYPE II TYPE V TYPE III EXPOSURE CATAGORY: A C B D	
BASIC WIND SPEED: 180 MPH (3-SECOND GUST) 170 MPH (3-SECOND GUST) 150 MPH (3-SECOND GUST) IMPORTANCE FACTOR: 0.77 (BUILDING CATEGORY 1) 1.00 (BUILDING CATEGORY II)	☐ 1.15 (BUILDING CATEGORY III) ☐ 1.15 (BUILDING CATEGORY IV)	WINDBORNE DEBRIS REGION: NO N/A YES IMPACT RESISTANT GLAZING IMPACT RESISTANT COVERING COMBINATION OF IMPACT RESISTANT GLAZING / COVERING	
BUILDING OCCUPANCY CLASSIFICATION: GROUP A - ASSEMBLY GROUP B - BUSINESS GROUP D - DAY CARE CENTER GROUP E - EDUCATIONAL GROUP F - FACTORY INDUSTRIAL GROUP H - HAZARDOUS	☐ GROUP I - INSTITUTIONAL ☐ GROUP M - MERCANTILE ☑ GROUP R - RESIDENTIAL ☐ GROUP S - STORAGE ☐ GROUP U - UTILITY/MISC.	INTERNAL PRESSURE COEFFICIENTS:	



CETIFICATE OF AUTHORIZATION No. 30470 5425 GOLDEN GATE PKWY, SUITE 2 NAPLES, FL 34116 PHONE: (239) 228.2054 FAX: (1) 877.807.2036 Email: encogroupinc@yahoo.com GROUP \Box


NCO NCO

JHS 14 NAPLES LLC SCREEN ENCLOSURE 94 29TH ST SW NAPLES, FLORIDA,34117

REVISIONS MK DATE DESCRIPTION OB NO: 21135E

DATE: 04/16/21 DRAWN BY: L. CARDONA CHK'D BY: A. PANQUEVA

SHEET NUMBER

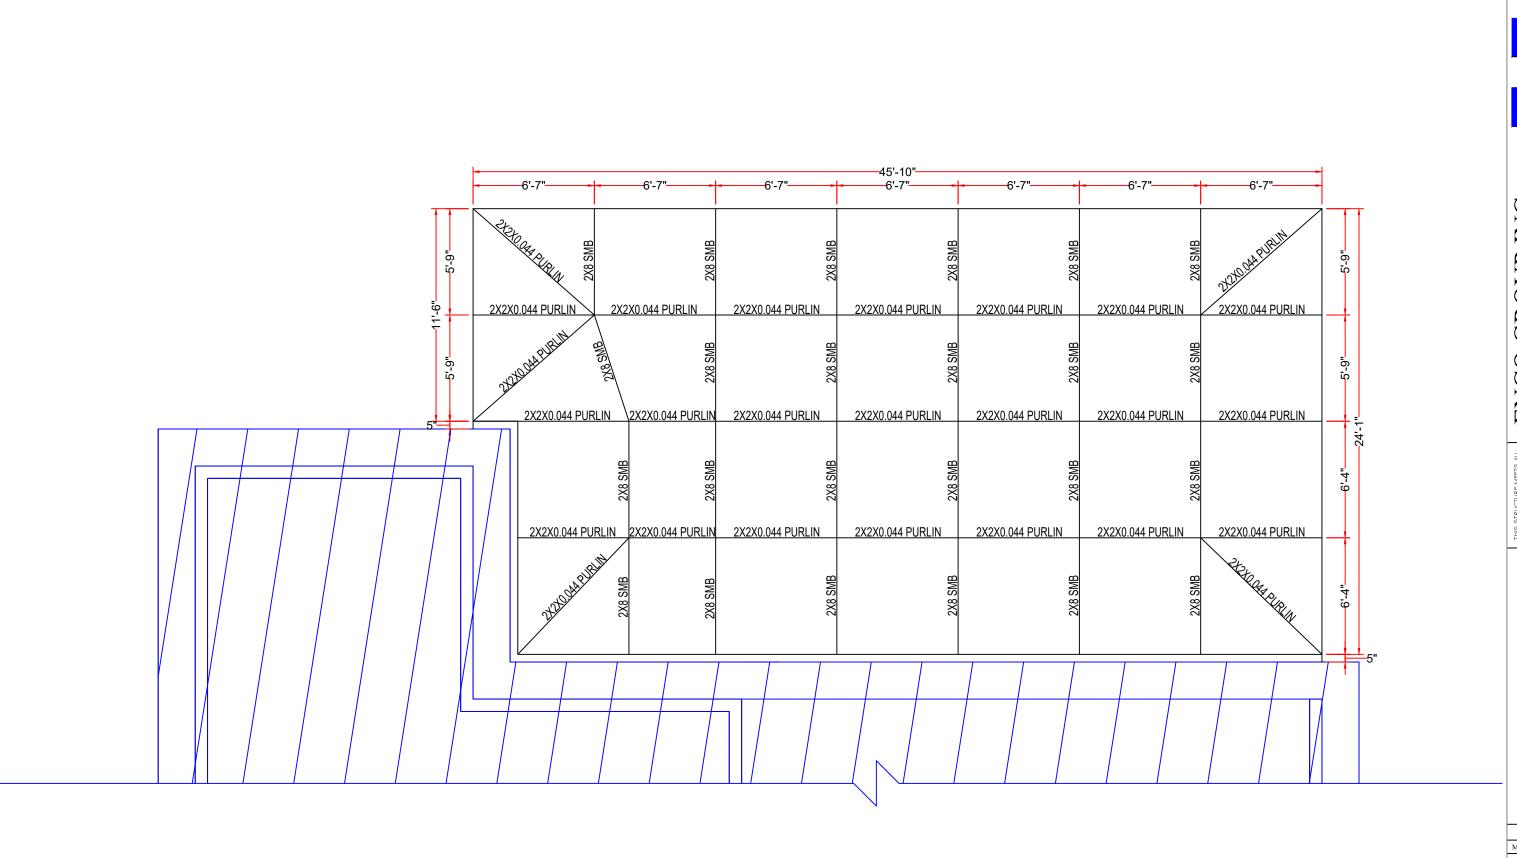

ENCO GROUP INC. CETIFICATE OF AUTHORIZATION No. 30470 5425 GOLDEN GATE PKWY, SUITE 2 NAPLES, FL 34116 PHONE: (239) 228.2054 FAX: (1) 877.807.2036 Email: encogroupinc@yahoo.com

ENCO GROUP INC.

JHS 14 NAPLES LLC SCREEN ENCLOSURE 94 29TH ST SW NAPLES, FLORIDA,34117

REVISIONS
MK DATE DESCRIPTION


JOB NO: 21135E DATE: 04/16/21 DRAWN BY: L. CARDONA CHK'D BY: A. PANQUEVA

SHEET NUMBER


ROOF PLAN SCALE: 3/16" = 1'-0"

REAR ELEVATION

SCALE: 3/16" = 1'-0"

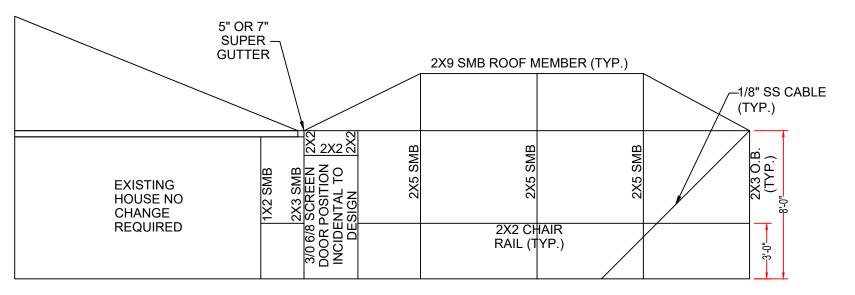

LEFT ELEVATION SCALE: 3/16" = 1'-0"

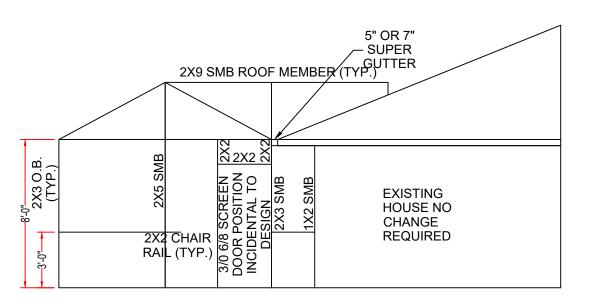

RIGHT ELEVATION



ENCO GROUP INC.


REQUIREMENTS OF THE 2020FLORDA BUILDING CODE


JHS 14 NAPLES LLC SCREEN ENCLOSURE 94 29TH ST SW NAPLES, FLORIDA, 34117


REVISIONS
MK DATE DESCRIPTION
JOB NO: 21135E


DATE: 04/16/21 DRAWN BY: L. CARDONA CHK'D BY: A. PANQUEVA

SHEET NUMBER

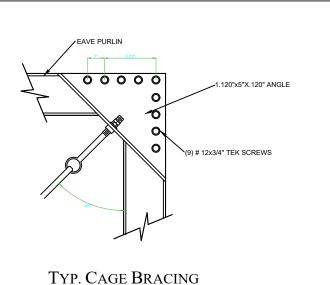

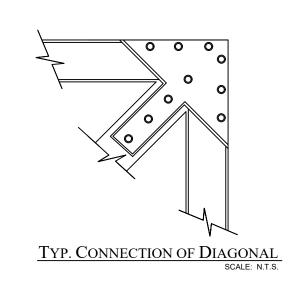


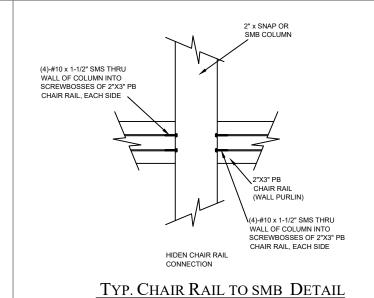


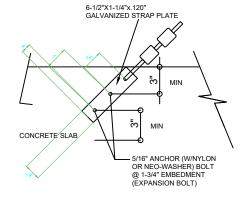



TYP. STRAP TO CONCRETE DETAIL SCALE: N.T.S.

2"x2" block to reinforce corner. 1/8" plate fastening corner together with the diagonal. Strap on inside of diagonal, Minimum of (4) #12x3/4" SDS into diagonal and (6) into eave rails.

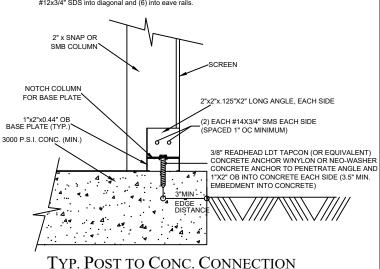

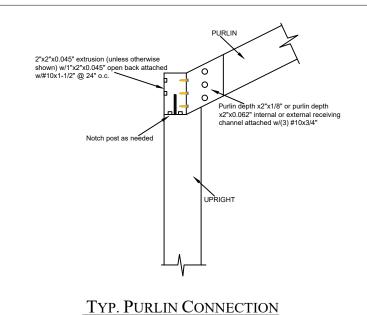

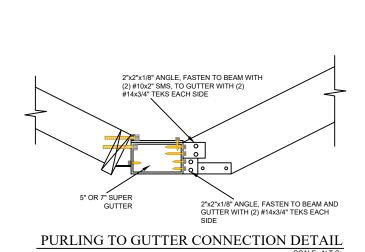


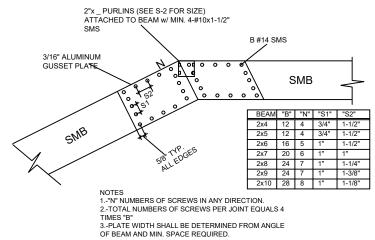

4.-GUSSET PLATES MAY BE INTERNAL OR EXTERNAL.
5.-INTERNAL SCREWS FOR PURLIN CONNECTION MAY
BE INCLUDED IN TOTAL NUMBERS OF SCREWS.
6.-GABLE SPLICE WILL HAVE THE SAME PATTERN.

TYP. BEAM SPLICE GUSSET DETAIL

2X2 X 1/8 ANGLE X (4) EACH #16 -3/6" X 4 1/2" HEX C/S S/S10
14 X 304 EA WAY. (TYP)
∤ }.
2x ALUMIN. MB
NOTCH POST AS NEEDED
4" x SNAP OR SMB COLUMN
NOTCH COLUMN FOR BASE PLATE
(4) LDT 3/8"X 7"(TYP) (2) EACH #16-3/8" X 4 1/2" HEX C/S S/S10 (SPACED 1" OC MINIMUM)
3000 P.S.I. CONC. (MIN.)
EMBEDMENT INTO CONCRETE) BODE BOTH
TYP. POST CONNECTION (TOP&BOTT.)

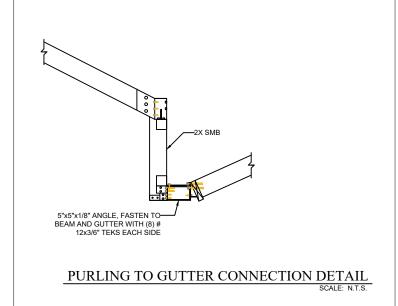

FASTENER	Min. Embedment	Allowable Shear Load	Allowable Tension Load	Material	Substrate Material	Fla. Product Approval
3/16" OTITEN Screw	1-1/4"	#220	#160	Carbon Steel	Hollow or Grout Filled CMU	2355.1
3/16" ØTITEN Screw	1-1/4"	#255	#305	Carbon Steel	Concrete	2355.1
3/16" OTITEN Screw	1-1/4"	#78	#78	Stainless Steel	Hollow or Grout Filled CMU	2355.1
1/4" OTITEN Screw	1-1/4"	#300	#165	Carbon Steel	Hollow or Grout Filled CMU	2355.1
1/4" OTITEN Screw	1-1/4"	#400	#365	Carbon Steel	Concrete	2355.1
1/4" OTITEN Screw	1-1/4"	#124	#137	Stainless Steel	Hollow or Grout Filled CMU	2355.1
3/8" OTITEN HDScrew	2-3/4"	#870	#480	Carbon Steel	Grouted CMU	11506.7
1/2" OTITEN HDScrew	3-1/2"	#1.385	#690	Carbon Steel	Grouted CMU	11506.7
5/8" OTITEN HDScrew	4-1/2"	#2.085	#1.060	Carbon Steel	Grouted CMU	11506.7
3/4" OTITEN HDScrew	5-1/2"	#3.000	#1.600	Carbon Steel	Grouted CMU	11506.7

REVISIONS
MK DATE DESCRIPTION

JHS 14 NAPLES LLC SCREEN ENCLOSURE 94 29TH ST SW NAPLES, FLORIDA,34117

ENCO GROUP INC

GROUP INC


ENCO

CETIFICATE OF AUTHORIZATION No. 30470 5425 GOLDEN GATE PKWY, SUITE 2 NAPLES, FL 34116 PHONE: (239) 228.2054 FAX: (1) 877.807.2036 Email: encogroupinc@yahoo.com

JOB NO: 21135E DATE: 04/16/21 DRAWN BY: L. CARDONA CHK'D BY: A. PANQUEVA

SHEET NUMBER

A-4

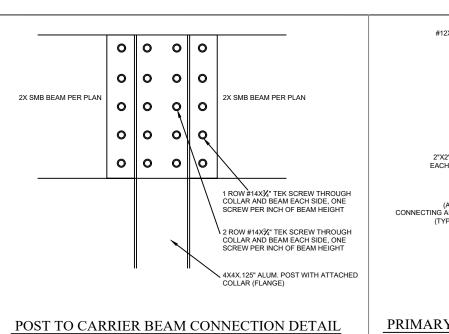

TOP VIEW

SIDE VIEW

0

0

0

#12X¾" TBK SCREW 24" O.C. TYP. PRIMARY BEAMS FLAT OR SLOPED 0 0 0 2"X2"X0.125" ANGLE 0 EACH SIDE OF BEAM (A) - #14X¾" SMS (CONNECTING ANGLE TO BEAM (TYP 4 LOCATIONS) CARRIER BEAM NOTES "A" SHALL BE EQUAL TO THE PRIMARY BEAM DEPTH IN INCHES (I.E. A 2X6 PRIMARY BEAM SHALL HAVE (6) #14 SMS (TYP 4 LOCATIONS))

PRIMARY BEAM TO CARRIER BEAM CONNECTION DETAIL

COLUMN PER PLAN.


BEAM PER PLAN-DOUBLE OR SINGLE

BEAM PER PLAN-DOUBLE OR SINGLE


NOTCH COLUMN TO RECEIVE BEAM, FASTEN BEAM TO COLUMN W/ (3)

3/8" HEX BOLT-NUT & LOCK WASHER


OR WASHER AND SELF LOCKING NUT

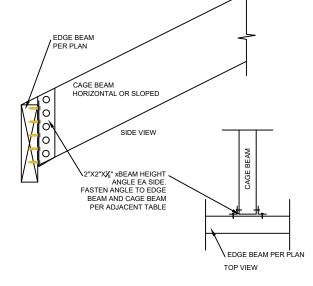


CAGE BEAM TO EDGE BEAM

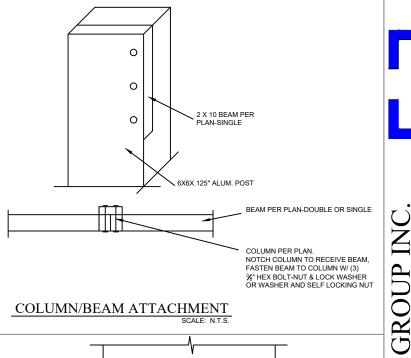

COLUMN/BEAM ATTACHMENT

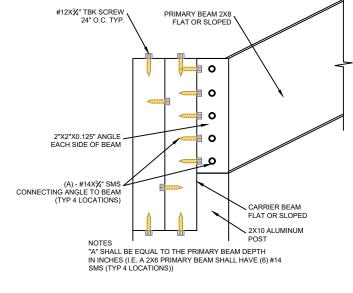



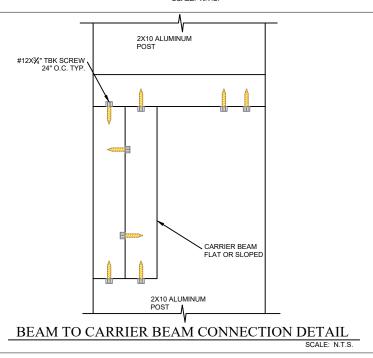

6X 6 COLUMN.

NOTCH COLUMN TO RECEIVE BEAM, 2X10 R. FASTEN BEAM TO COLUMN W/ (3) 1/2" HEX BOLT-NUT & LOCK WASHER OR WASHER AND SELF LOCKING NUT



COLUMN/BEAM CONNECTION

PROVIDE %" INTERNAL CHANNEL CUT TO FIT W/ NO SLIP TOLERANCE. FASTEN TO COLUMN WITH (2) 3/8" HEX BOLT-NUT AND LOCK WASHER OR LOCKING NUT-ALTERNATELY FASTEN W/ #14X9/16" SMS(3) EACH, SIDE

LOCKING NUT

SMS (3) EACH SIDE

#14X9/16"

PROVIDE 1/8"X2"X2" ANGLE EA SIDE

FASTEN TO CONCRETE W/(2) 3/8"X5" TAPCON

EACH SIDE FASTEN TO COLUMN W/ (2) %" HEX BOLT-NUT AND LOCK WASHER OR

ALTERNATELY FASTEN TO COLUMN W/

COLUMN/BEAM ATTACHMENT DETAILS

TOP VIEW

JHS 14 NAPLES LLC SCREEN ENCLOSURE 94 29TH ST SW NAPLES, FLORIDA,34117

NCO GROUP INC

CETIFICATE OF AUTHORIZATION No. 30470 5425 GOLDEN GATE PKWY, SUITE 2 NAPLES, FL 34116 PHONE: (239) 228.2054 FAX: (1) 877.807.2036 Email: encogroupinc@yahoo.com

ENCO

REVISIONS MK DATE DESCRIPTION JOB NO: 21135E

DATE:04/16/21 DRAWN BY: L. CARDONA CHK'D BY: A. PANQUEVA

SHEET NUMBER