# **DESIGN CRITERIA:**

APPLICABLE CODES, REGULATIONS & STANDARDS

- 1. THE 2020 FLORIDA BUILDING CODE, SPECIFICALLY CHAPTER 16 STRUCTURAL DESIGN, CHAPTER 20 ALUMINUM & CH. 23 WOOD.
- 2. AA ASM 35 & SPECIFICATIONS FOR ALUMINUM STRUCTURES, PART 1-A OF THE ALUMINUM DESIGN MANUAL PREPARED BY THE ALUMINUM ASSOCIATION, INC. WASHINGTON D.C. 2005 ED.
- 3. ASCE 7-16 & SE17
- 4. NDS NATIONAL DESIGN SPECIFICATION FOR WOOD.
  5. ACI318 CONCRETE REFERENCE MANUAL.

#### WIND LOADS:

- 1. BUILDING OCCUPANCY CATEGORY, PARAGRAPH 1604.5 & TABLE 1604.5: RISK CATEGORY 1.
- 2. BASIC WIND SPEED, TABLE 1609C, STATE OF FLORIDA DEBRIS
  REGION & BASIC WIND SPEED, PARAGRAPH 1609.3.1 & TABLE
  1609.3.1 EQUIVALENT BASIC WIND SPEED:
  MPH EXPOSURE CATEGORY, PARAGRAPH 1609.4.3:
- 3. WIND LOADS PER FBC TABLE 2002.4 (MWFRS) VULT = 150 MPH & EXPOSURE = C

## FOR 20 X 20 X 0.013" MESH SCREEN

HORIZONTAL PRESSURES ON WINDWARD SURFACES = 34 PSF 12 PSF HORIZONTAL PRESSURES ON LEEWARD SURFACES = VERTICAL PRESSURES ON SCREEN SURFACES = VERTICAL PRESSURES ON SOLID SURFACES = 36 PSF

FOR 18 X 14 X 0.013" MESH SCREEN, APPLIED FACTOR = FOR ALLOWABLE STRESS DESIGN, APPLIED FACTOR =

#### FOUNDATION DESIGN:

FOOTING SIZE EXISTING CONCRETE SLAB. NO ADDITIONAL FOOTING OR FOUNDATION SYSTEM IS REQUIRED BY THE PROPOSED CONSTRUCTION IF A MINIMUM 4" CONCRETE SLAB IS PROVIDED IN SOUND CONDITION, FREE FROM STRUCTURAL CRACKING, SPALLING & OTHER DETERIORATION. EXISTING FOUNDATION/FOOTING UNDER CONCRETE SLAB MINIMUM 8'X8" W/ (1) #5 BAR TO BE VERIFIED BY CONTRACTOR. SEE TYPICAL FOOTING DETAILS FOR NEW FOOTING DESIGN MINIMUM REQUIREMENTS.

## MISCELLANEOUS:

1. SCREENED ENCLOSURES CONTAINING SWIMMING POOLS SHALL COMPLY WITH THE APPLICABLE REQUIREMENTS OF FBC R4501.17 RESIDENTIAL SWIMMING BARRIER REQUIREMENTS.

2. ALUMINUM ADDITIONS ARE NOT TO BE INSTALLED ON A MANUFACTURED HOME, TRAILER HOME, OR PRE-FAB HOME. IF THE EXISTING STRUCTURE IS ONE OF THESE, A SEPARATE 4TH WALL SUPPORT SYSTEM IS SO TO BE ENGINEERED SO THAT NO ADDITIONAL LOADING IS PLACED ON THE MANUFACTURED HOME.


#### FASTENER SPECIFICATIONS:

- 1. FASTENERS ARE REQUIRED TO BE SAE GRADE 2 OR BETTER ZINC PLATED. (CONCRETE ANCHORS ARE TO BE TAPCONS OR BETTER, INSTALLED TO MFG. SPECIFICATIONS)
- 2. IT IS THE OWNERS RESPONSIBILITY TO MAINTAIN THE SCREENS, FASTENERS AND SCREENS TO MANUFACTURING SPECIFICATIONS.
- 3. WHERE WOOD DECK IS PRESENT USE 1/4" X 3-1/2" GALV. LAG SCREWS IN LIEU OF MASONRY ANCHORS. UNLESS OTHERWISE SPECIFIED.
- 4. 1"XZ" NON STRUCTURAL MEMBERS ATTACHED TO HOST A. FOR MASONRY/CONCRETE APPLICATION USE GALVANIZED 1/4" X 2-3/4" TAPCONS OR EQUAL AT 24" O.C. AND 6" FROM ENDS B. FOR WOOD APPLICATION USE #14 X 2-3/4" WOOD SCREW AT 24" O.C. AND 6" FROM ENDS.
- C. FOR ALUMINUM APPLICATION USE #10 X 1-1/2" SMS OR TEK SCREW AT 24" O.C. AND 6" FROM ENDS D. WHERE 1"X2" INSTALLED THROUGHOUT AN "OPEN VIEW" SPACING SHALL BE REDUCED TO 18" O.C. AND 6" FROM ENDS

- 1. ALL SITE WORK SHALL BE PERFORMED BY A LICENSED CONTRACTOR IN ACCORDANCE WITH APPLICABLE BUILDING CODES, LOCAL ORDANANCES, AND THE ENGINEER SHALL BE NOTIFIED OF ANY DISCREPANCIES.
- 2. FOR FASTENERS WHICH ARE NOT VISIBLE AFTER INSTALLATION, THE CONTRACTOR SHALL VERIFY AND ENSURE INSTALLATION HAS BEEN ACCOMPLISHED IN ACCORDANCE WITH MANUFACTURERS SPECIFICATIONS AND IN ACCORDANCE WITH THE ATTACHED DETAILS.
- 3. FOR "PICTURE WINDOW" MODIFICATION TO EXISTING SCREEN ENCLOSURES, ALL OTHER "EXISTING SCREEN ENCLOSURE" FEATURES ARE TO MEET THE TYPICAL DETAILS AS PROVIDED IN THESE DETAILS. CONTRACTOR IS TO VERIFY & ASSURE EXISTING SCREEN ENCLOSURE IS STRUCTURALLY SOUND.
- 4. CONTRACTOR TO PROVIDE NOA'S & INSTALL ALL MATERIALS AS PER MANUFACTURER'S SPECIFICATIONS.
- 5. INTEGRITY OF EXISTING/ HOST STRUCTURE SHALL NOT BE COMPROMISED WITH THE ATTACHMENT OF THE PROPOSED STRUCTURE.

| SHEET NO. | DRAWING INDEX    |  |
|-----------|------------------|--|
| \$/01     | GENERAL NOTES    |  |
| \$/02     | PLAN/ ELEVATIONS |  |
| \$/03     | DETAILS          |  |
| \$/04     | DETAILS          |  |
| \$/05     | DETAILS          |  |

ALLOWABLE STRESS IS 21.2 KSI

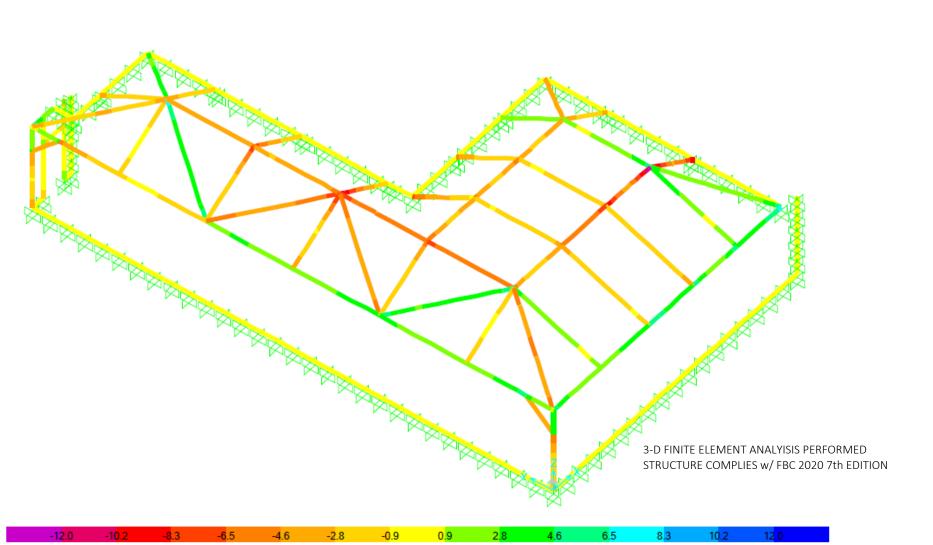

Kip, in, F

PROPOSED MANSARD SCREEN ENCLOSURE SEE FOUNDATION PLAN SHEET-03

ENGINEERING LLC 101 L N O I TAMIAMI TRAIL, UNIT T CHARLOTTE, FLORIDA 3 (941) 391-5980 ÈLÉng.com Orders@FLEng.com ORIDA 4161 PORT S. **PROJECT** 34146 SCREENS OVER MARCO P.O. BOX 801 MARCO ISLAND, FL 3414  $^{\circ}$ WEAKLEY 4612 MERGANSER C NAPLES, FL 34119 PROJECT ADDRESS **DESIGN DATE:** 01/26/2023 **REVISION 1:** 02/21/2023 REVISION 2: SHEET: DRAWN BY: SCALE: NTS

**ALUMINUM SPECIFICATIONS:** 

- ALUMINUM EXTRUSIONS SHALL BE 6005 T5 ALLOY UNLESS OTHERWISE NOTED.

   ALL SELF MATING BEAM SECTIONS ARE TO BE STITCHED WITH #12 SCREWS 6" FROM ENDS & 24" CENTER TO CENTER.

  #10 SCREW 6" FROM ENDS & 12" CENTER TO CENTER.

  2 POOL PRACTICE SHALL BE AND WHALL STY AND STORY.

  \*\*TO CENTER TO CENTER.\*\*

  \*\*TO CENTER.\*\*

  \*\*TO CENTER TO CENTER.\*\*

  \*\*TO CENTER.\*\*

  \*
- #10 SCREW 6" FROM ENDS & 12" CENTER TO CENETER.

  3. ROOF BRACING SHALL BE A MINIMUM 2"X4"X.050".

  4. THE MINIMUM NORMAL THICKNESS OF PROTECTOR PANELS (KICKPLATES) SHALL BE AN INDUSTRY STANDARD OF 0.024 INCHES.

  5. VINYL AND ACRYLIC PANELS SHALL BE REMOVED WHEN WIND SPEEDS EXCEED 75 MPH PER FBC.

  6. SCREEN MATERIAL SHALL BE 18/14 SCREEN UNLESS APPROVED BY FLORIDA ENGINEERING LLC.

  7. 1"X2" & 1"X3" NON STRUCTURAL MEMBERS MAY BE USED INTERCHANGEABLY.

  8. DOOR LOCATION MAY BE DETERMINED/ RELOCATED BY CONTRACTOR IN THE FIELD.


  9. NO CABLES REQUIRED PER SITE SPECIFIC ANALYSIS.

- 9. NO CABLES REQUIRED PER SITE SPECIFIC ANALYSIS.

# HATCH/ SYMBOL LEGEND

| HATCH | INDICATES        |  |
|-------|------------------|--|
|       | EXIST. STRUCTURE |  |

NOTE: ALL MAY NOT APPLY

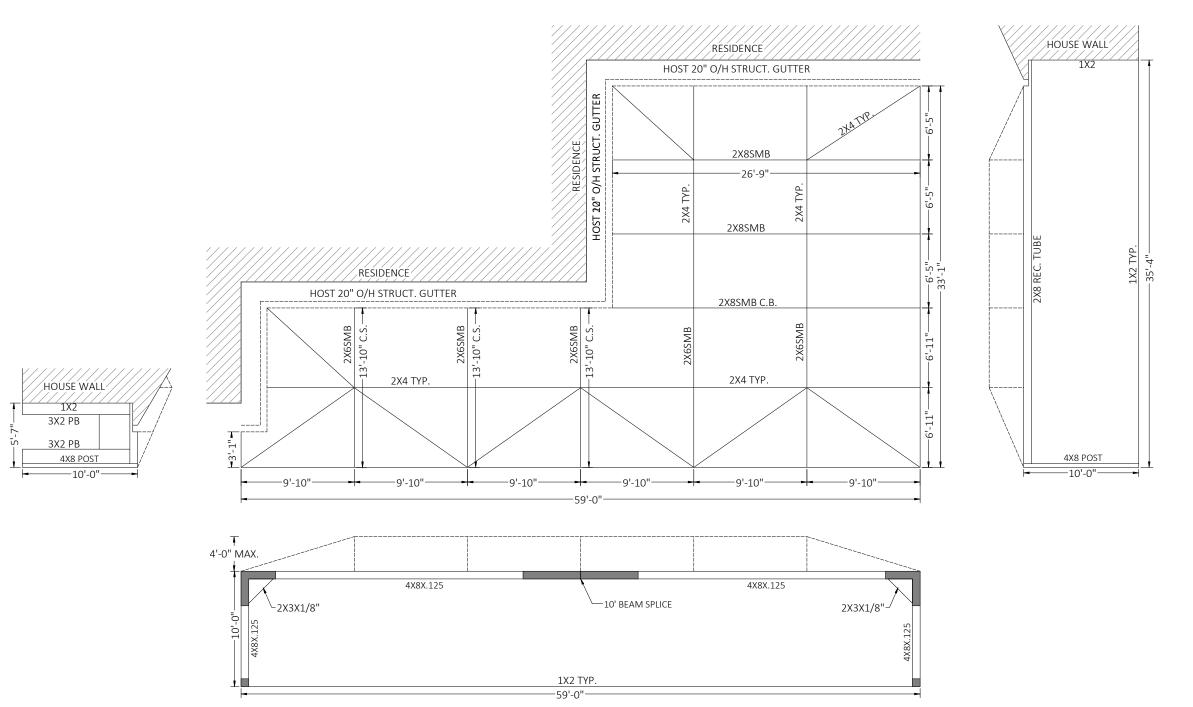

This item has been electronically signed and sealed by Craig E. Gunderson, P. E. on date below using a Digital Signature. Printed copies of this document are not considered signed and sealed and the signature must be verified on any electronic copies.

4161 TAMIAMI TRAIL, UNIT 101
PORT CHARLOTTE, FLORIDA 33952
(941) 391-5980
FLEng.com
Orders@FLEng.com FLORIDA ENGINEERING LLC

CA CERT. #30782

2302553-2


PROJECT NO.

34146 SCREENS OVER MARCO P.O. BOX 801 MARCO ISLAND, FL 34146 WEAKLEY 4612 MERGANSER CT NAPLES, FL 34119 OJECT ADDRESS:

| 8            | PR     |                   |
|--------------|--------|-------------------|
| DESIGN DATE: | 01/26/ | 2023              |
| REVISION 1:  | 02/21/ | 2023              |
| REVISION 2:  | DATE   | SHEET             |
| DRAWN BY:    | SH     | $\mathbf{\Omega}$ |

NTS

SCALE:

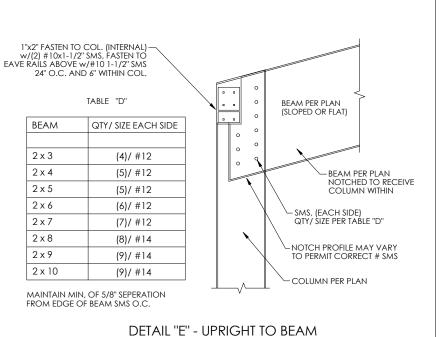

CONNECTION SCALE: NTS

MINIMUM NUMBER OF TAPCONS INTO CONCRETE &

# 12 X 3/4" S.M.S. INTO UPRIGHT / EACH SIDE OF BEAM THROUGH SECONDARY 2" X 2" X 0.125" ANGLES

(SEE BELOW)

2X4 S.M.B. (1) 1/4" X 2-1/4" S.S. TAPCON & (2) # 12 X 3/4" S.M.S.

2X5 S.M.B. (1) 1/4" X 2-1/4" S.S. TAPCON & (2) # 12 X 3/4" S.M.S.

2X6 S.M.B. (2) 1/4" X 2-1/4" S.S. TAPCON & (3) # 12 X 3/4" S.M.S.

2X7 S.M.B. (2) 1/4" X 2-1/4" S.S. TAPCON & (3) # 12 X 3/4" S.M.S. 2X8 S.M.B. (3) 1/4" X 2-1/4" S.S. TAPCON & (4) # 12 X 3/4" S.M.S. 2X8 S.M.B. (3) 1/4" X 2-1/4" S.S. TAPCON & (5) # 12 X 3/4" S.M.S. 2X9 S.M.B. (4) 1/4" X 2-1/4" S.S. TAPCON & (6) # 12 X 3/4" S.M.S. 2X10 S.M.B. (5) 1/4" X 2-1/4" S.S. TAPCON & (7) # 12 X 3/4" S.M.S.

SIDE VIEW

1/8"x2"x2"x ANGLE

(2) - #12 SMS INTO COLUMN 1/4" MASONRY ANCHOR FACH ANGLE - EACH SIDE COL.


ANCHOR EMBEDMENT

@ SECONDARY ANGLE

3000 PSI CONC.

6x6-10x10 WWM OR FIBERMESH

SLAB/ FTG

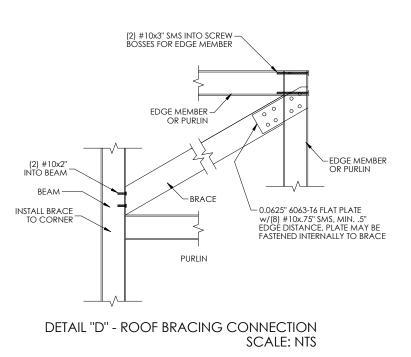

ALUMINUM MEMBERS DIMENSIONS: **HOLLOW SECTIONS** 2 x 2: 2" x 2" x 0.050' 2 x 3: 2" x 3" x 0.050' 2 x 4: 2" x 4" x 0.050' 2 x 5: 2" x 5" x 0.050' OPEN BACK SECTIONS 1 x 2: 1" x 2" x 0.044" 1 x 3: 1" x 3" x 0.045"

SNAP SECTIONS

2 x 2 SNAP: 2" x 2" x 0.045" 2 x 3 SNAP: 2" x 3" x 0.050" 2 x 4 SNAP: 2" x 4" x 0.045"

SELF MATING (SMB) 2 x 4 SMB: 2" x 4" x 0.046" x 0.100" 2 x 5 SMB: 2" x 5" x 0.050" x 0.116" 2 x 6 SMB: 2" x 6" x 0.050" x 0.120" 2 x 7 SMB: 2" x 7" x 0.055" x 0.120" 2 x 8 SMB: 2" x 8" x 0.072" x 0.224" 2 x 9 SMB: 2" x 9" x 0.072" x 0.224" 2 x 9(H) SMB: 2" x 9" x 0.082" x 0.306' 2 x 10 SMB: 2" x 10" x 0.092" x 0.374" ALL MAY NOT APPLY DETAIL A



-(4) #10x1-1/2" SMS INTO SCREW BOSSES

101


CA CERT.

2302553-

PROJECT NO.

 $\Box$ 

WEAKLEY 4612 MERGANSER C NAPLES, FL 34119

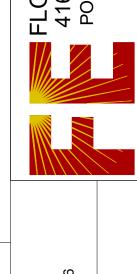




SCALE:

DESIGN DATE: 01/26/2023 02/21/2023 REVISION 1: **REVISION 2:** DATE SHEET: DRAWN BY: SH

NTS

2" MIN. INCREASE DISTANCE WHEN GREATER THAN 2x4 UPRIGHT IS USED WHERE PAVERS ARE PRESENT USE 5/16"
TAPCON XL (RED HEAD MFG.) MASONRY ANCHORS TO PENETRATE UNDERLYING CONCRETE FOOTING 2-1/4" (MIN.)

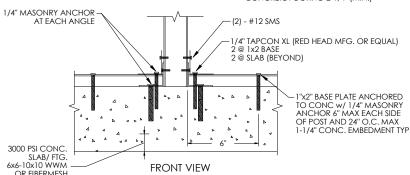

SELE-MATING OR

1"x2" O.B. BASE PLATE-TYP


-1/4" MIN CONC


ANCHOR EMBEDMENT

@ 1"x2" O.B. LOCATION TYP.

2" REVEAL TYP.

DETAIL "B" - 2"x4" OR LARGER SELF MATING UPRIGHT TO DECK DETAILS SCALE: NTS

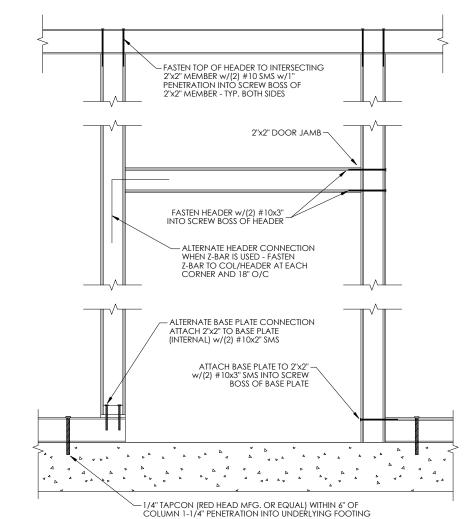

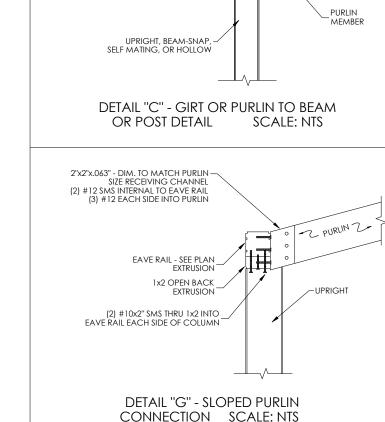

ALUMINUM INTERNAL OR EXTERNAL RECEIVING CHANNEL W/(4) #10x.75" INTO GIRT OR PURLIN & (2) #14x.75" INTO BEAM OR UPRIGHT 0.062 ANGLE

CLIPS MAYBE USED

DETAIL "F" - DOOR JAMB & HEADER CONNECTION **SCALE: NTS** 

