THE TEALE - NAPLES BUILDING B N A P L E S A

PROJECT DESCRIPTION

THIS PROJECT IS CHANGE OF USE AND LEVEL 2 ALTERATION TO AN EXISTING FOUR-STORY TYPE 3B RESIDENTIAL GROUP R1 HOTEL BUILDING WITH A FIRST OCCUPANCY OF 1989 TO CREATE PRIVATE RESIDENTIAL GROUP R2 WORKFORCE MULTIFAMILY APARTMENT HOUSING WITH ENCLOSED AND UNENCLOSED AMENITY AREAS RESTRICTED TO USE BY RESIDENTS AND RESIDENT GUESTS USING FEBC PERFORMANCE COMPLIANCE METHOD. THERE IS ARE NO PROPOSED CHANGES TO THE EXISTING BUILDING STRUCTURAL SYSTEM, FOOTPRINT, FIRE AREA, MEANS OF EGRESS, EXIT ACCESS, EGRESS COMPONENTS, OR ELEVATOR.

P200

P201

P301

E302

E303

E304

E305

E306

E307

E308

E402


E403


THIS PROJECT DOES NOT INCREASE EXISTING BUILDING HORIZONTAL OR VERTICAL FIRE SEPARATION REQUIREMENTS.

ARCHITECTURE

HEET

LOCATION MAPS

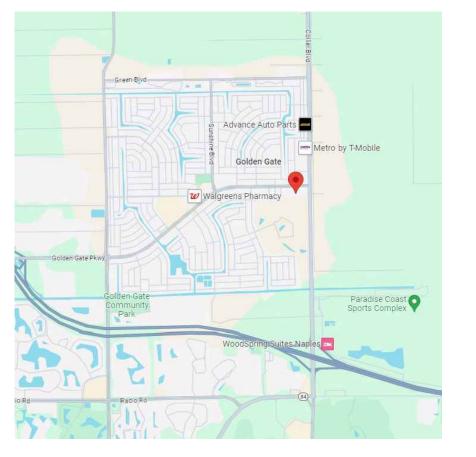

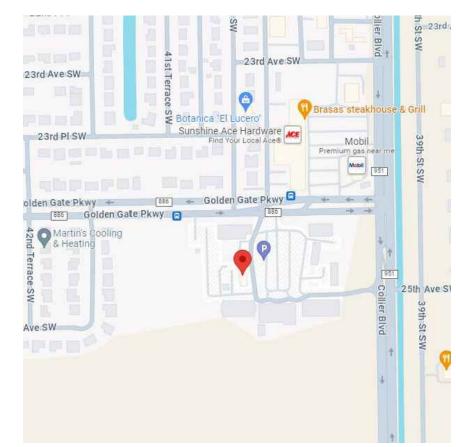

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S001 S101 S102 S103

P

A-000

A-001

A-002

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ELECTRICAL RISERS

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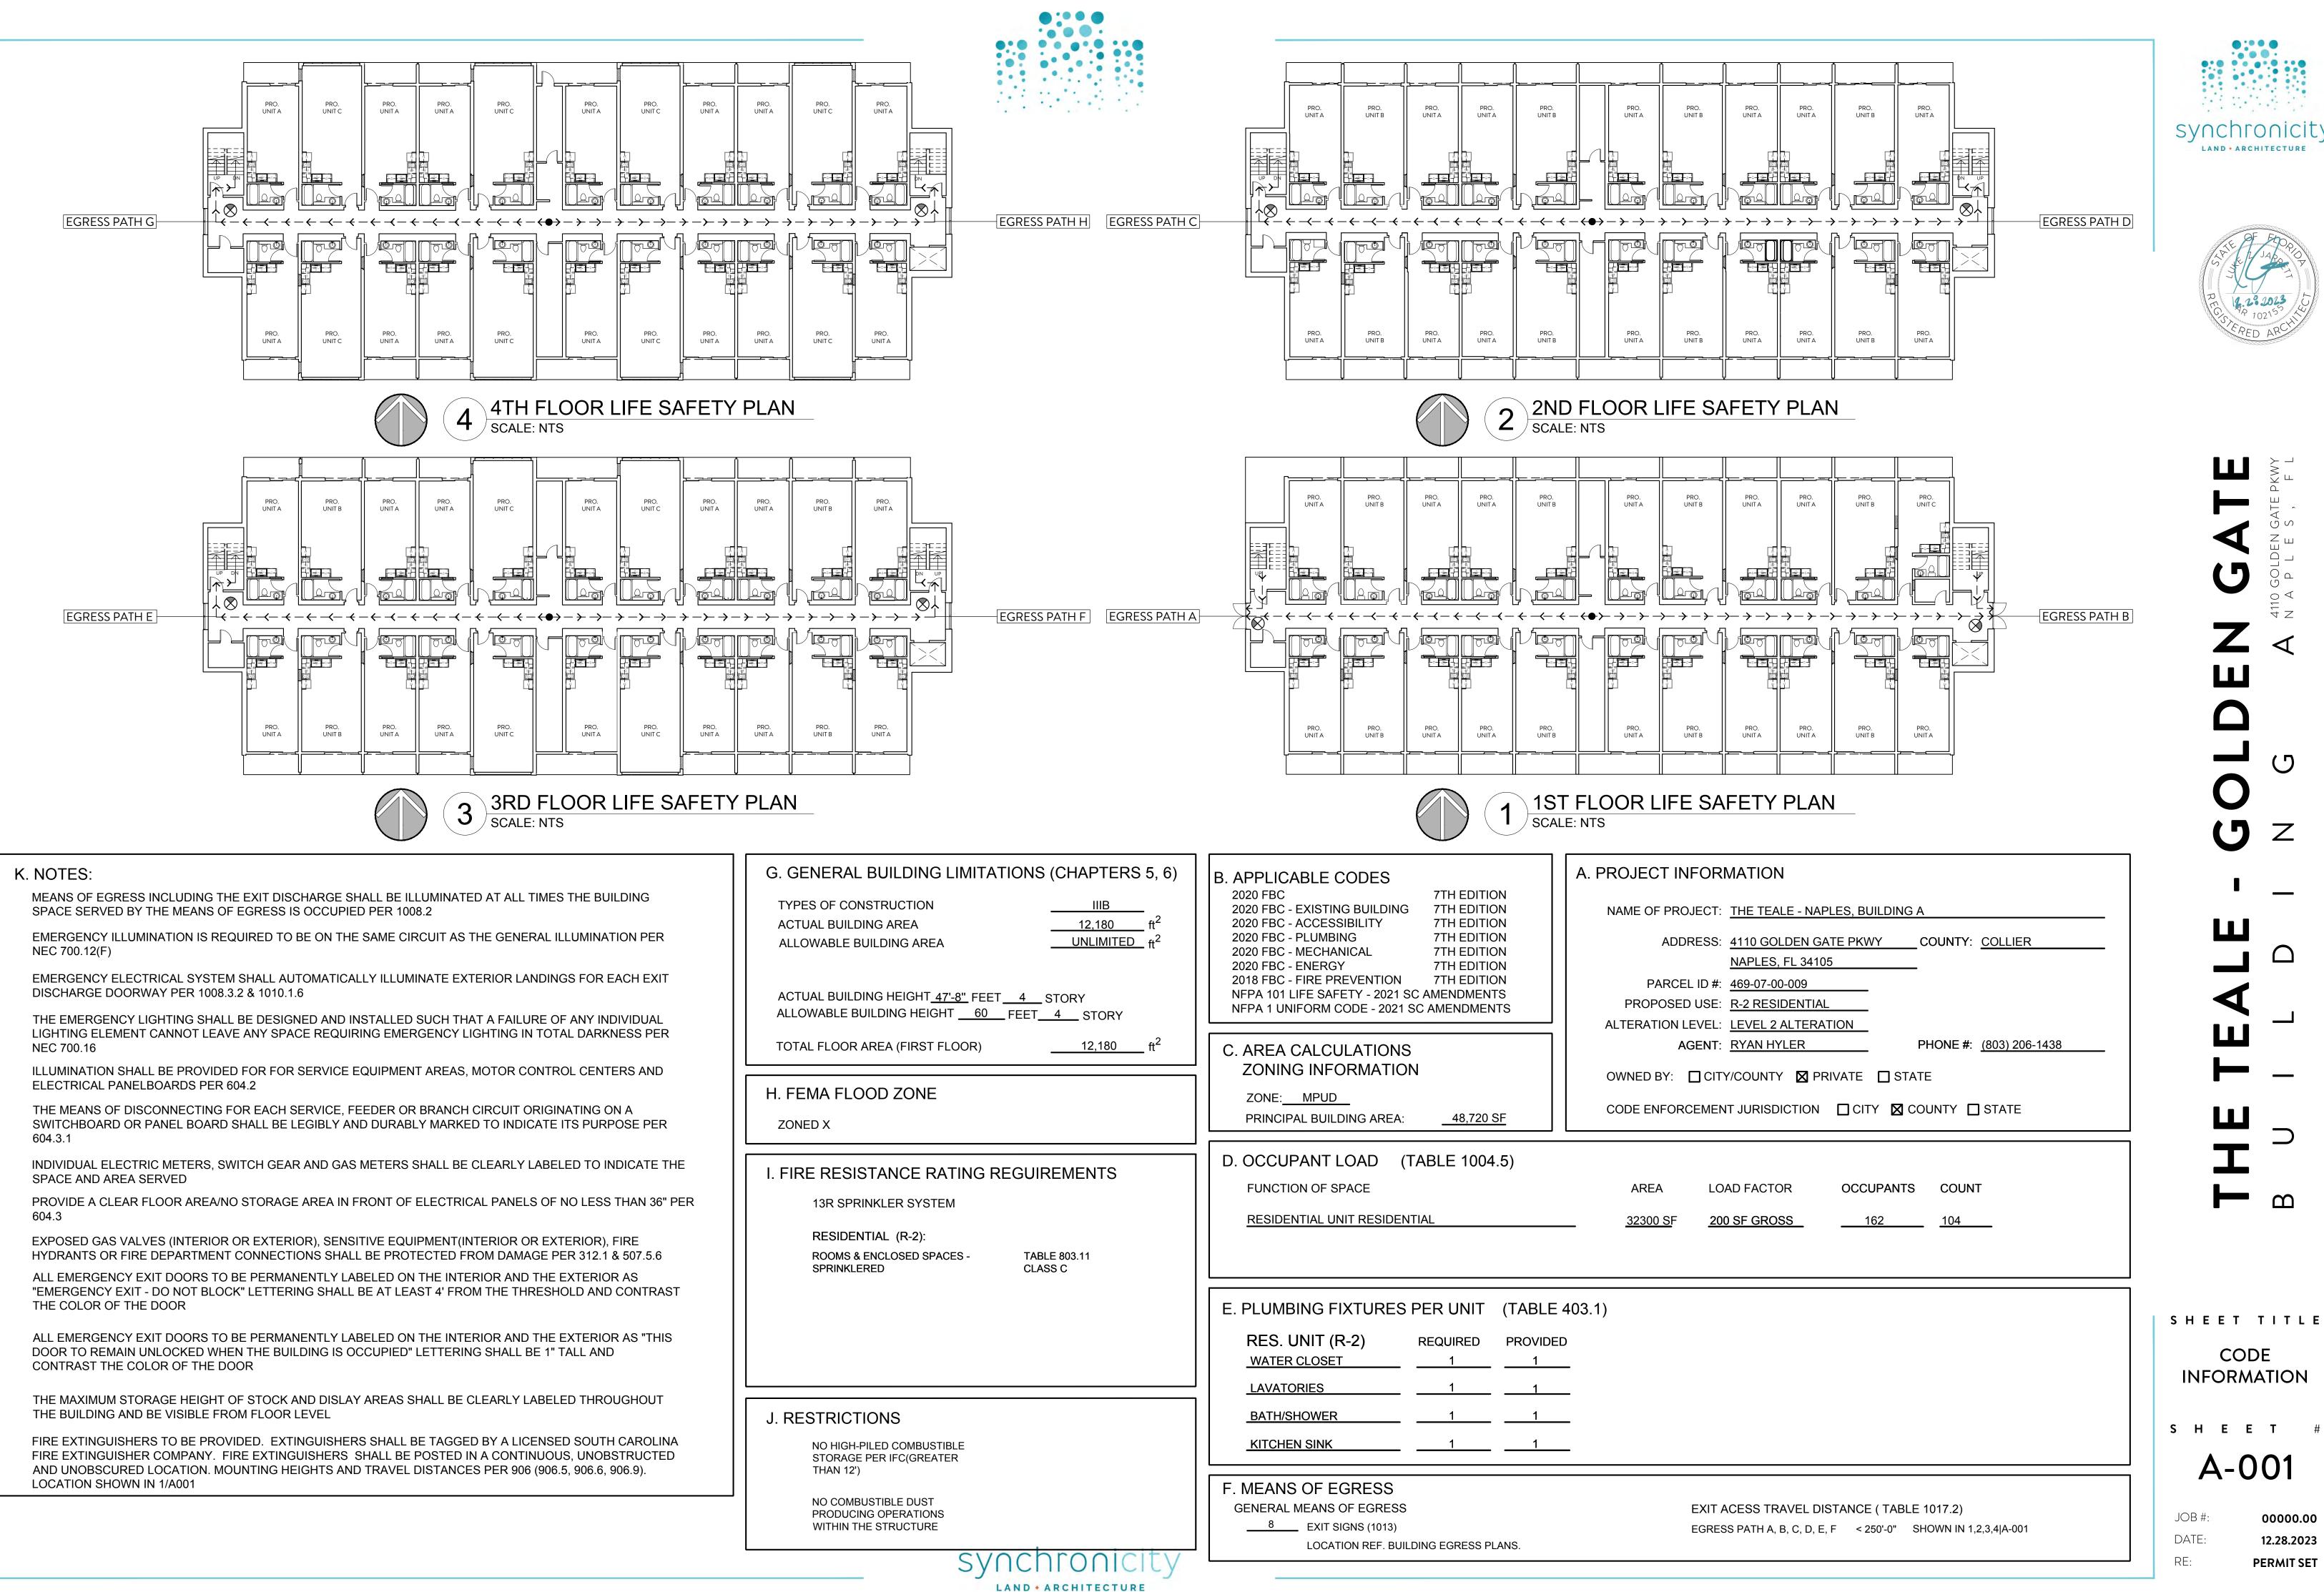
SHEET TITLE **INDEX**

SHEET# A-000

JOB#: DATE:








SHEET TITLE CODE

INFORMATION

JOB #: 00000.00 DATE: 12.28.2023 **PERMIT SET**

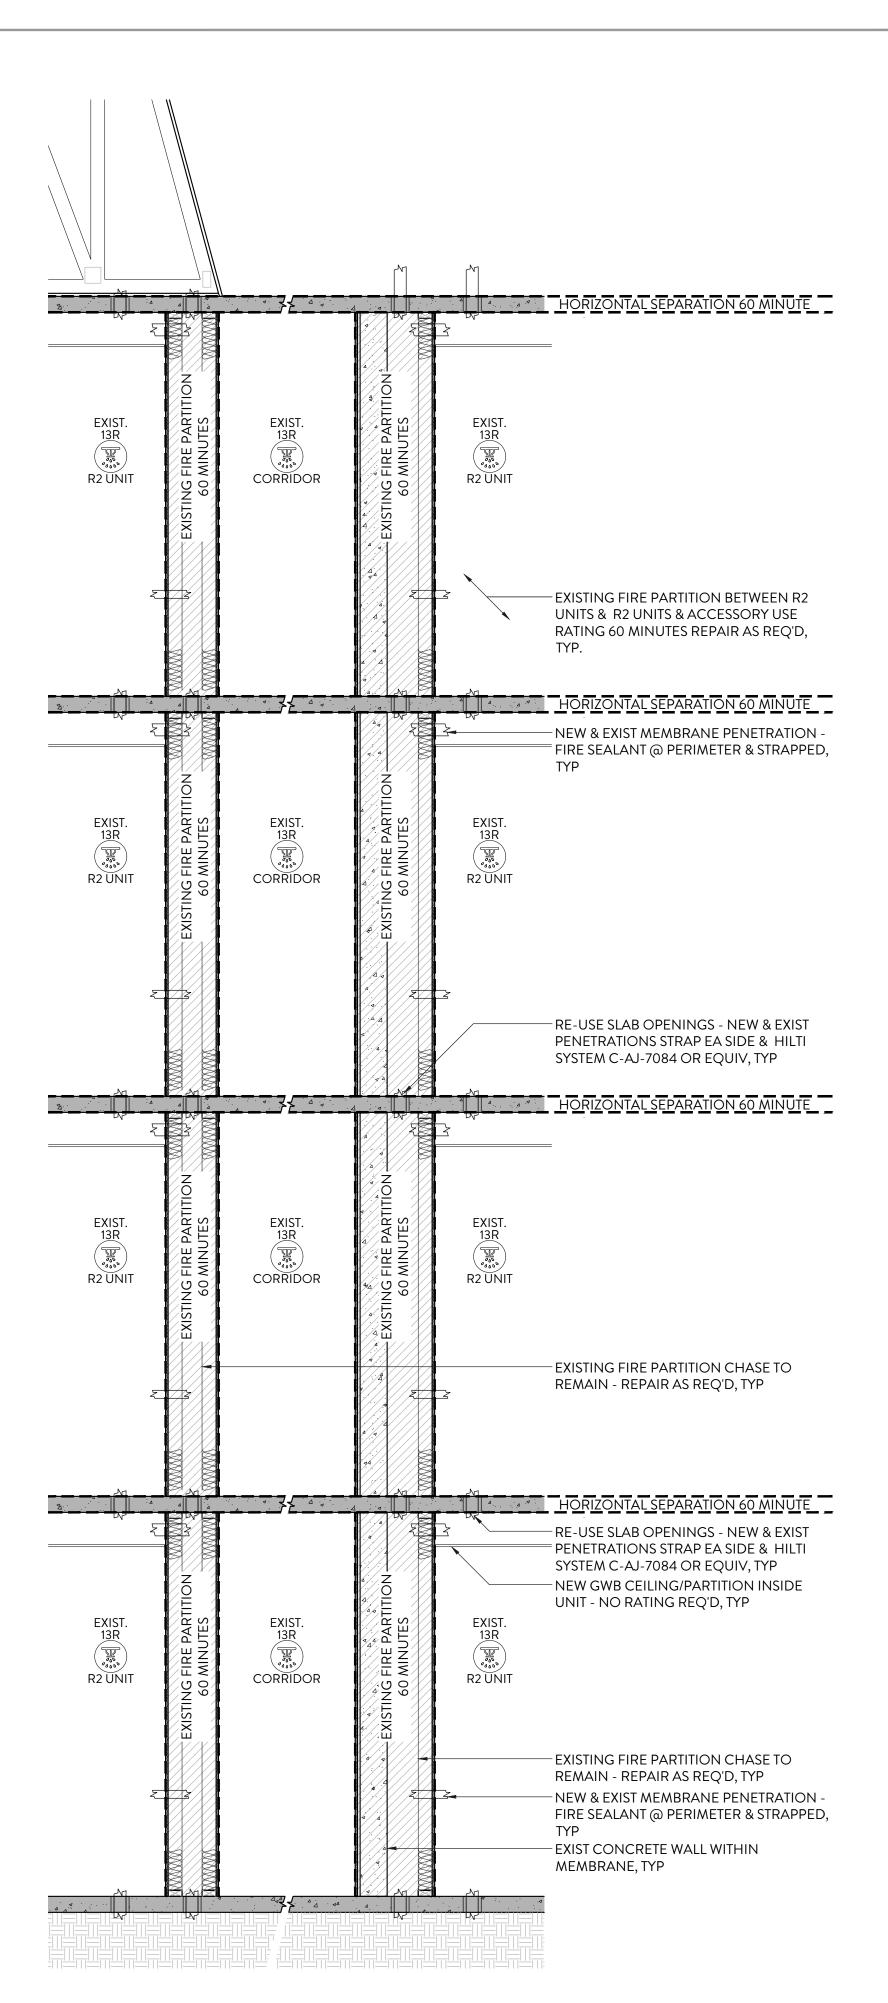

2 TYP. BULIDING SECTION @ MAIN CHASE SCALE: 1/2"=1'-0" @ 24"x36" OR 1/4"=1'-0" @ 12"X18"



TABLE 1401.7 SUMMARY SHEET- BUILDING CODE

Existing occupancy RESIDENTIAL R1	Proposed occupancy RESIDENTIAL R2
Year building was constructed1989	Number of stories 4 Height in feet 48
Type of construction 3B	Area per floor 11801 SF
Percentage of open perimeter increase <u>37</u> %	Corridor wall rating 1 HOUR
Completely suppressed: Yes X No_	Type: CATEGORY C
Compartmentation: Yes X No 2 H	Required door closers: Yes X No No
Fire-resistance rating of vertical opening enclosures 2 H Type of HVAC system CATEGORY E	, serving number of floors 1
Automatic fire detection: Yes X No	
Fire alarm system: Yes X No	
Smoke control: Yes_XNo	Type: CATEGORY B
Adequate exit routes: Yes X No	Dead ends: Yes No
Maximum exit access travel distance 90'	Elevator controls: Yes No _X
Means of egress emergency lighting: Yes X No	Mixed occupancies: Yes No _X
Standpipes Yes_XNo	Patient ability for self-preservation NA
Incidental use YesNo_X	Patient concentration NA
Smoke compartmentation less than 22,500 sq. feet (2092 m²) Yes X No	Attendant-to-patient ratio NA
SAFETY PARAMETERS	FIRE SAFETY (FS) MEANS OF EGRESS (ME) GENERAL SAFETY (GS)

SAFETY PARAMETERS	FIRE SAFETY (FS)	MEANS OF EGRESS (ME)	GENERAL SAFETY (GS)
	FIRE SAFETY (FS)	MEANS OF EGRESS (ME)	GENERAL SAFETY (GS)
1401.6.1 Building Height	1	1	1
1401.6.2 Building Area	11.5	11.5	11.5
1401.6.3 Compartmentation	4	4	4
1401.6.4 Tenant and Dwelling Unit Separations	2	2	2
1401.6.5 Corridor Walls	0	0	0
1401.6.6 Vertical Openings	2	2	2
1401.6.7 HVAC Systems	5	5	5
1401.6.8 Automatic Fire Detection	6	6	6
1401.6.9 Fire Alarm System	0	0	0
1401.6.10 Smoke control	* * * *	2	2
1401.6.11 Means of Egress	* * * *	0	0
1401.6.12 Dead ends	* * * *	2	2
1401.6.13 Maximum Exit Access Travel Distance	* * * *	12	12
1401.6.14 Elevator Control	0	0	0
1401.6.15 Means of Egress Emergency Lighting	* * * *	1	1
1401.6.16 Mixed Occupancies	0	* * **	0
1401.6.17 Automatic Sprinklers	4	4 ÷2 = 2	4
1401.6.18 Standpipes	4	4	4
1401.6.19 Incidental Use	0	0	0
1401.6.20 Smoke compartmentation	0	0	0
1401.6.21.1 Patient ability for self-preservation	* * * *	NA	NA
1401.6.21.2 Patient concentration	* * * *	NA	NA
1401.6.21.3 Attendant-to-patient Ratio	* * *	NA	NA
Building score—total value			

^{* * * *}No applicable value to be inserted.

TABLE 1401.9 EVALUATION FORMULAS

FORMULA	T1401.7	T1401.8		SCORE	PASS	FAIL
FS-MFS≥0	39.5 (FS)	21 (MFS)	4 1/7	18.5	X	
WE-WWESO	54.5_(ME)=	38 (MME)	#	16.5	X	**************************************
GS-MGS≥0	<u>56.5</u> (GS)—	38 (MGS)	Cape PP	<u>18.5.</u>	<u> X</u> .:	<u> </u>

ACCESSIBILITY NOTES

THIS IS AN EXISTING BUILDING WITH FIRST OCCUPANCY IN 1989 THAT WILL UNDERGO A CHANGE OF USE AND LEVEL 2 ALTERATION TO CREATE PRIVATE RESIDENTIAL GROUP R-2 WORKFORCE MULTIFAMILY HOUSING WITH ENCLOSED AND UNENCLOSED AMENITY AREAS RESTRICTED TO USE BY RESIDENTS AND RESIDENT GUESTS.


IT IS OUR UNDERSTANDING THAT AS INDIVIDUALLY OWNED OR LEASED HOUSING IN THE PRIVATE SECTOR NOT USED AS A PUBLIC ACCOMMODATION, INCLUDING SINGLE FAMILY HOMES, CONDOMINIUMS, OR APARTMENTS, PER ADA STANDARDS, FHA ACCESSIBILITY GUIDELINES, AND THE STATE OF FLORIDA BUILDING COMMISSION DECLARATORY STATEMENT DS 2013-11 PERTAINING TO THE FLORIDA BUILDING CODE ACCESSIBILITY CODE:

- THE EXISTING BUILDING, ITS INTERNAL CIRCULATION, AND ITS ATTENDANT ENCLOSED AND UNENCLOSED AMENITY AREAS (RESTRICTED TO USE BY RESIDENTS AND RESIDENT GUESTS) ARE NOT REQUIRED TO BE ACCESSIBLE
- 2. ACCESSIBLE RESIDENTIAL UNITS ARE NOT REQUIRED
- 3. TYPE A RESIDENTIAL UNITS ARE NOT REQUIRED
- 4. TYPE B RESIDENTIAL UNITS ARE NOT REQUIRED
- THE RESIDENTIAL MULTIFAMILY LEASING OFFICE IS A PLACE OF PUBLIC ACCOMMODATION. THE LEASING OFFICE AND ITS RESTROOMS ARE LOCATED IN A SEPARATE BUILDING AND SHALL BE ACCESSIBLE AND CONNECTED TO ACCESSIBLE PARKING WITH AN ACCESSIBLE ROUTE.

FLORIDA EXISTING BUIDLING CODE NOTES

PER FLORIDA EXISTING BUILDING CODE THIS PROJECT IS CHANGE OF USE AND LEVEL 2 ALTERATION TO AN EXISTING BUILDING USING 301.3.3 PERFORMANCE COMPLIANCE METHOD. THE FOLLOWING NOTES APPLY TO THIS PROJECT:

- NO INCREASE TO THE EXISTING BUILDING FOOTPRINT
- NO MODIFICATION TO THE EXISTING BUILDING STRUCTURAL SYSTEM
- NO MODIFICATION TO THE EXISTING BUILDING MEANS OF EGRESS
- NO MODIFICATION TO THE EXISTING BUILDING ELEVATOR
- THIS PROJECT DOES NOT INCREASE EXISTING BUILDING HORIZONTAL
 OR VERTICAL FIRE SEPARATION REQUIREMENTS
- EXISTING FIRE SEPARATION SYSTEMS ARE TO BE RE-USED WITH REPAIRS AS REQUIRED.

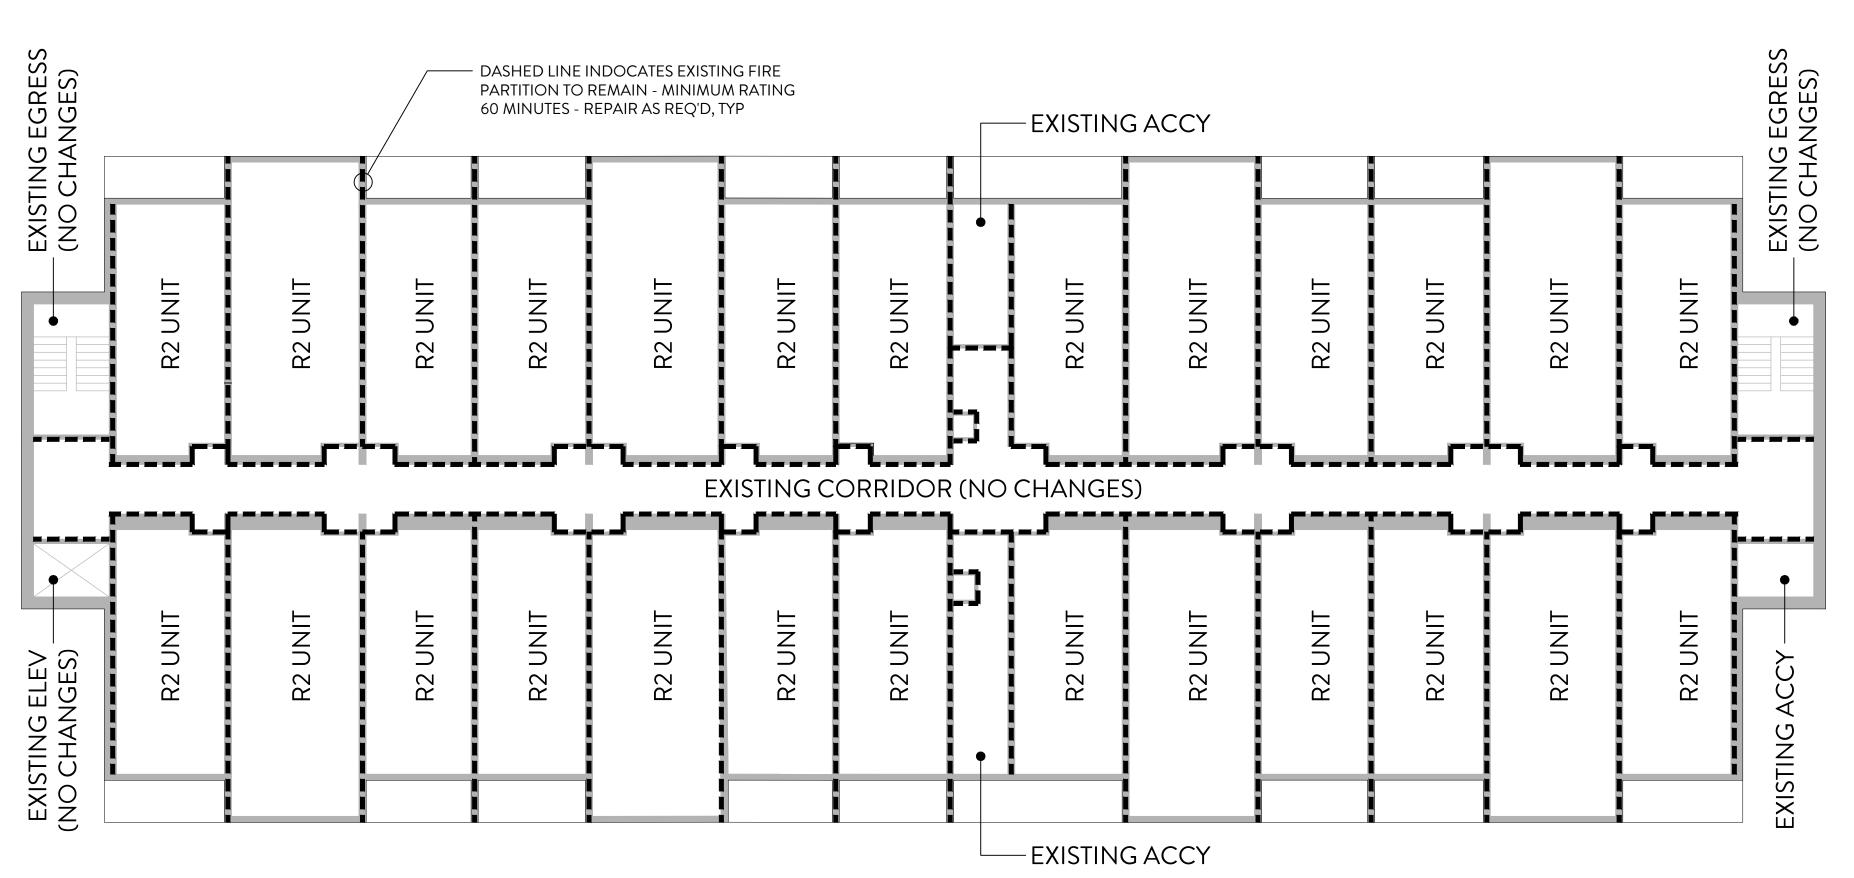

TYP. FLOOR USE/RATED WALL DIAGRAM SCALE: NTS







THETER GOLDEN GATE PKW

SHEET TITLE

ACCESSIBILITY & FEBC CODE

S H E E T #

A-002


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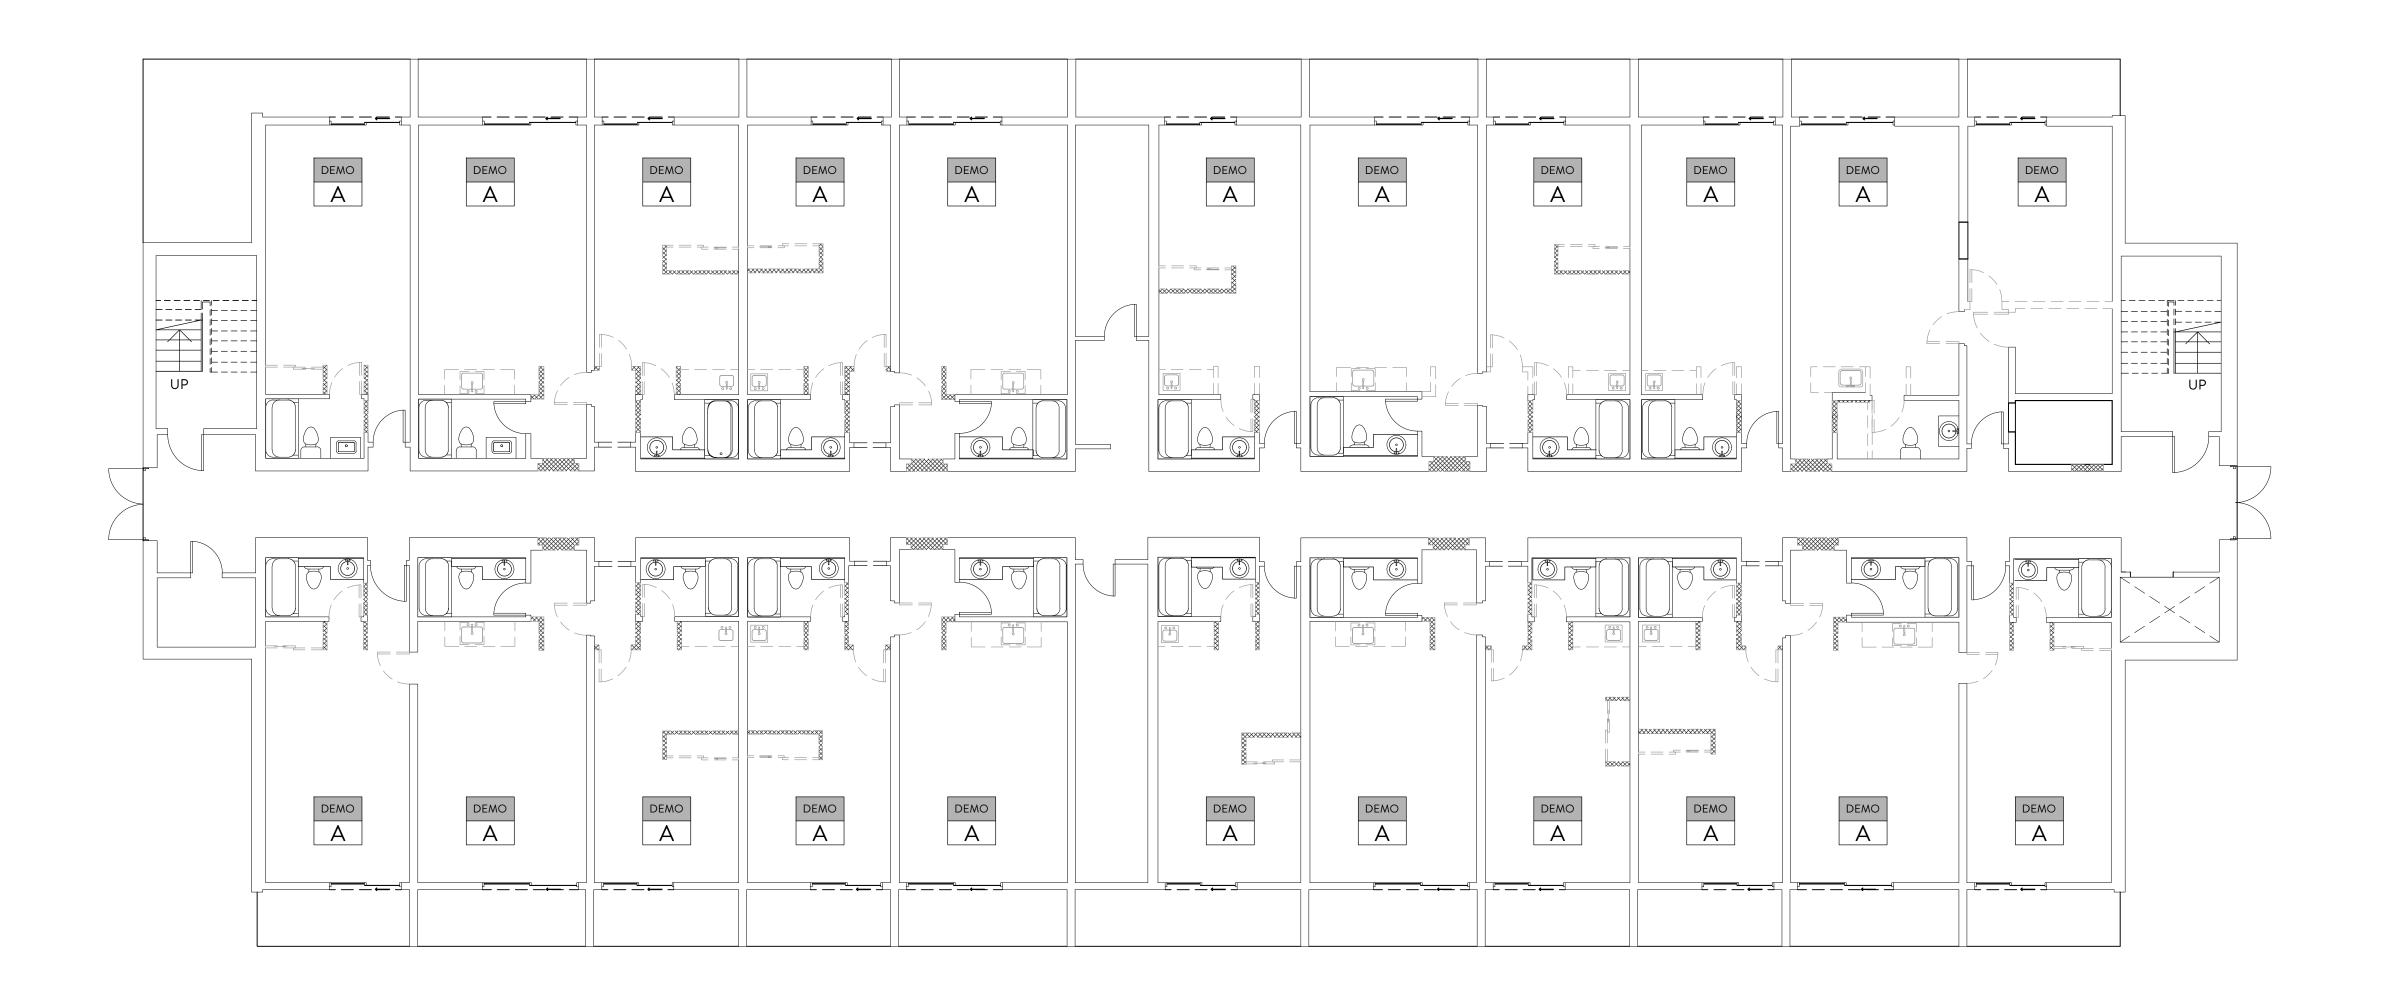
SITE PLAN

A-100

SHEET#

JOB #: DATE:



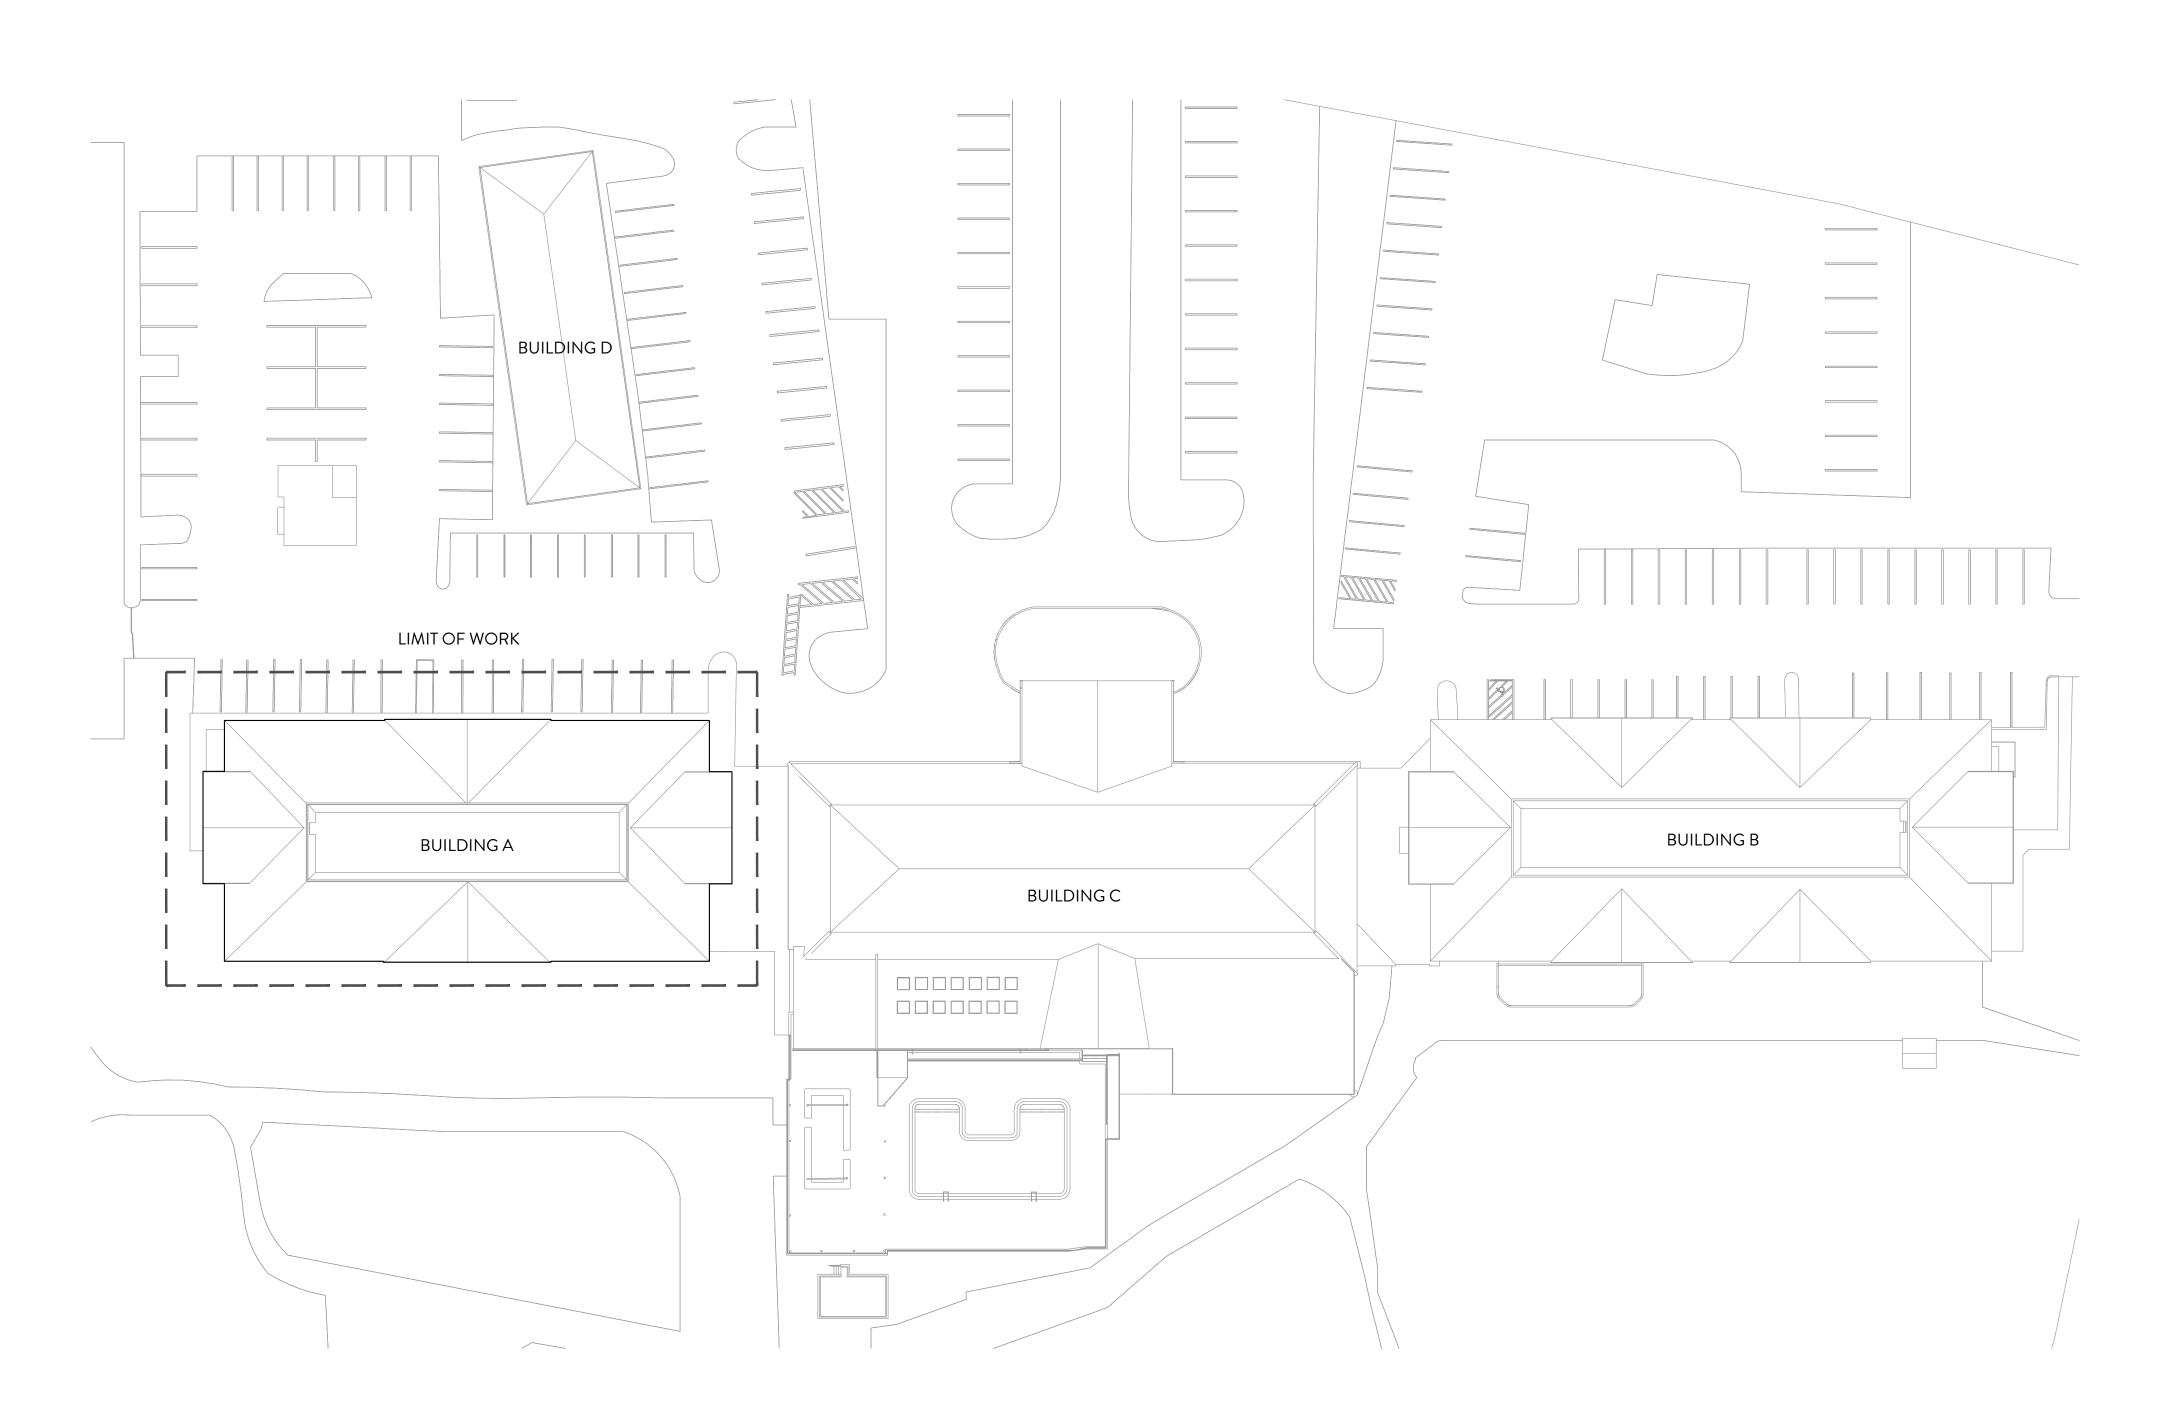

- STRUCTURAL ENGINEER SHALL REVIEW & APPROVE ALL PARTITIONS PRIOR TO COMPLETE DEMOLITION
- ALL EXISTING SANITARY SYSTEMS ARE TO REMAIN
- **EXISTING EXTERIOR LIGHTING** SYSTEMS DEMOLITION IS LIMITED TO REMOVING FIXTURES. FIXTURES WILL BE REPLACED DURING CONSTRUCTION. THE DESIGN INTENT IS RE-USE OF EXTERIOR LIGHTING WIRING & BOXES
- ALL DOOR SYSTEMS BETWEEN GUESTROOMS ARE TO BE DEMOLISHED COMPLETELY
- SLAB CORE CUTS REQUIRED AT ALL NEW ELEC. PANEL CHASES & SRINKLER RISER
- EXISTING ELEVATOR TO REMAIN
- IF DISCREPANCIES ARE FOUND OR IF ANY DRAWING IS UNCLEAR GC SHALL NOTIFY ARCHITECT AND BE GIVEN DIRECTION OR CLARIFICATION PER THE ORIGINAL DESIGN INTENT BY THE ARCHITECT BEFORE PROCEEDING WITH AFFECTED WORK.

DEMOLITION LEGEND

SELECTIVE DEMOLITION

DEMOLITION: GUESTROOM DEMOLISH COMPLETE INTERIOR PARTITIONS & DOORS AS INDICATED. SELECTIVE DEMOLITION LIMITED TO REMOVAL OF EXISTING PANEL, P/M/E FIXTURES & FLOOR FINISHES. CAP & ABANDON IN PLACE ELECTRICAL & SUPPLY WATER IN AREAS OTHER THAN PARTITIONS. SANITARY & EF SYSTEMS TO BE RE-USED. CREATE OPENING FOR NEW DOORS.





SHEET TITLE

EXISTING FIRST FLOOR PLAN

SHEET#


A-101

DATE:







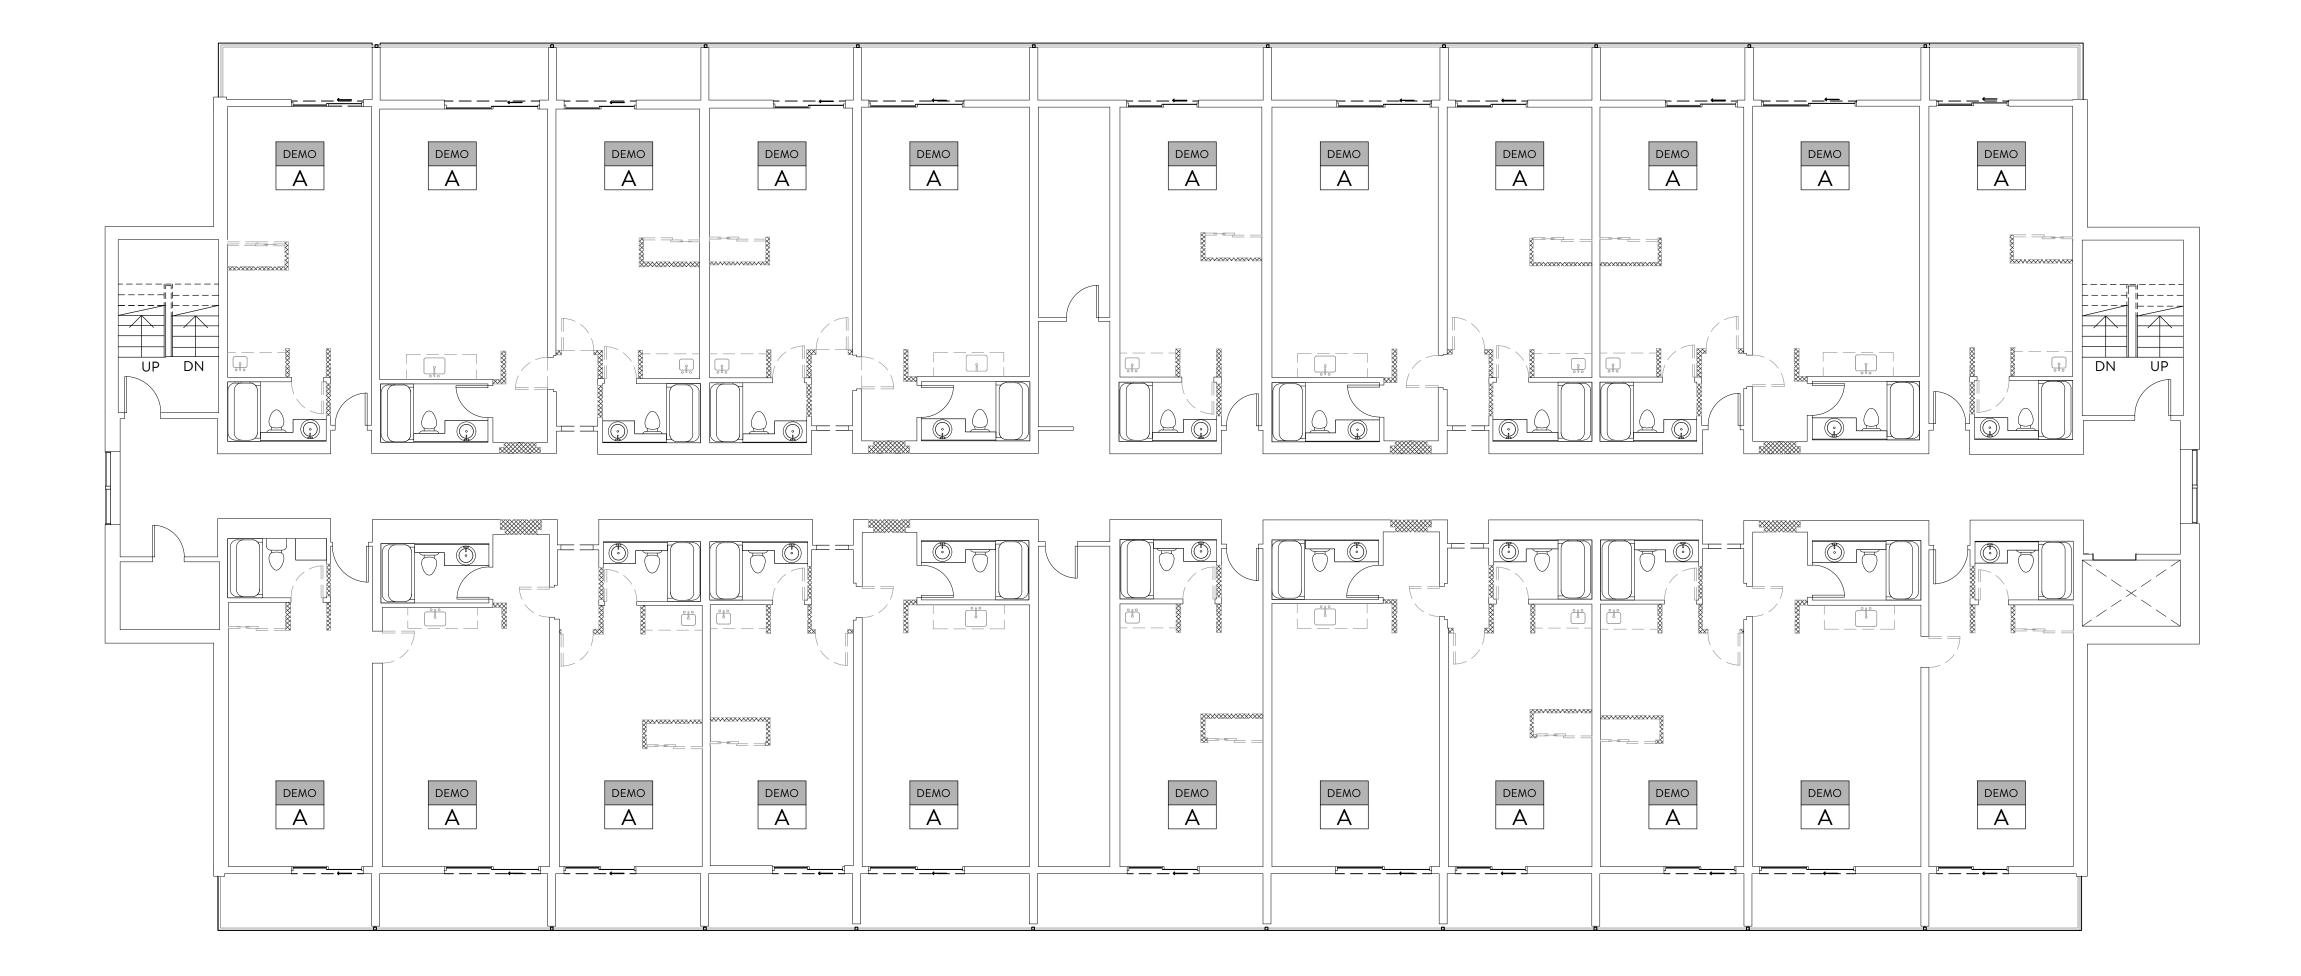

- STRUCTURAL ENGINEER SHALL REVIEW & APPROVE ALL PARTITIONS PRIOR TO COMPLETE DEMOLITION
- ALL EXISTING SANITARY SYSTEMS ARE TO REMAIN
- EXISTING EXTERIOR LIGHTING SYSTEMS DEMOLITION IS LIMITED TO REMOVING FIXTURES. FIXTURES WILL BE REPLACED DURING CONSTRUCTION. THE DESIGN INTENT IS RE-USE OF EXTERIOR LIGHTING WIRING & BOXES
- ALL DOOR SYSTEMS BETWEEN GUESTROOMS ARE TO BE DEMOLISHED COMPLETELY
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DEMOLITION LEGEND

SELECTIVE DEMOLITION

DEMOLITION: GUESTROOM DEMOLISH COMPLETE INTERIOR PARTITIONS & DOORS AS INDICATED. SELECTIVE DEMOLITION LIMITED TO REMOVAL OF EXISTING PANEL, P/M/E FIXTURES & FLOOR FINISHES. CAP &

ABANDON IN PLACE ELECTRICAL & SUPPLY WATER IN AREAS OTHER THAN PARTITIONS. SANITARY & EF SYSTEMS TO BE RE-USED. CREATE OPENING FOR

NEW DOORS.





SHEET TITLE **EXISTING** SECOND FLOOR


SHEET#

A-102

PLAN

JOB #: DATE:

00000.00 12.28.2023 **PERMIT SET**

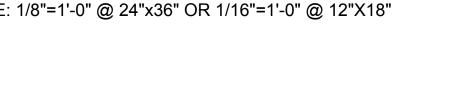


synchronicity

LAND . ARCHITECTURE

SECOND FLOOR PLAN



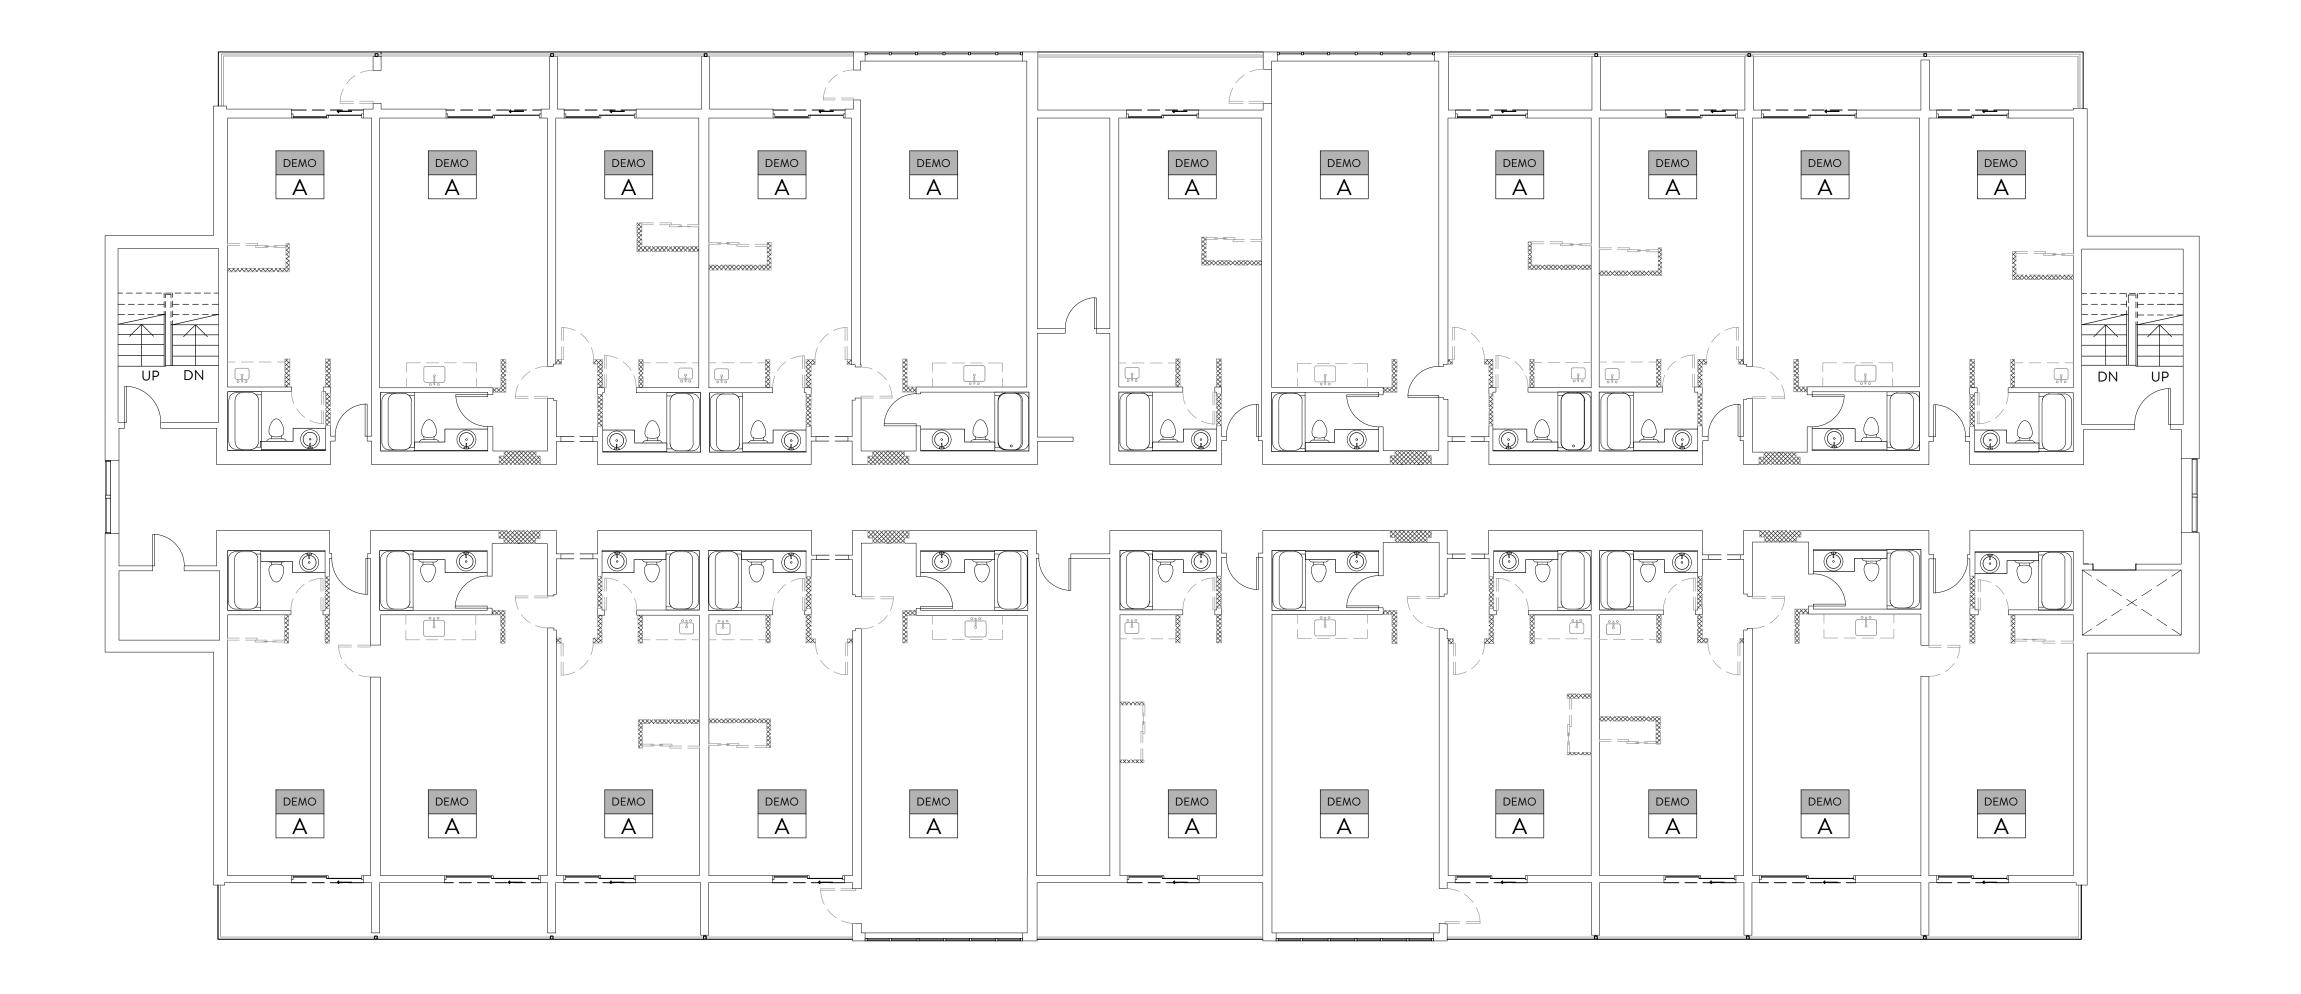

- STRUCTURAL ENGINEER SHALL REVIEW & APPROVE ALL PARTITIONS PRIOR TO COMPLETE DEMOLITION
- ALL EXISTING SANITARY SYSTEMS ARE TO REMAIN
- EXISTING EXTERIOR LIGHTING SYSTEMS DEMOLITION IS LIMITED TO REMOVING FIXTURES. FIXTURES WILL BE REPLACED DURING CONSTRUCTION. THE DESIGN INTENT IS RE-USE OF EXTERIOR LIGHTING WIRING & BOXES
- ALL DOOR SYSTEMS BETWEEN GUESTROOMS ARE TO BE DEMOLISHED COMPLETELY
- SLAB CORE CUTS REQUIRED AT ALL NEW ELEC. PANEL CHASES & SRINKLER RISER
- EXISTING ELEVATOR TO REMAIN
- IF DISCREPANCIES ARE FOUND OR IF ANY DRAWING IS UNCLEAR GC SHALL NOTIFY ARCHITECT AND BE GIVEN DIRECTION OR CLARIFICATION PER THE ORIGINAL DESIGN INTENT BY THE ARCHITECT BEFORE PROCEEDING WITH AFFECTED WORK.

DEMOLITION LEGEND

SELECTIVE DEMOLITION

DEMOLITION: GUESTROOM

DEMOLISH COMPLETE INTERIOR PARTITIONS & DOORS AS INDICATED. SELECTIVE DEMOLITION LIMITED TO REMOVAL OF EXISTING PANEL, P/M/E FIXTURES & FLOOR FINISHES. CAP & ABANDON IN PLACE ELECTRICAL & SUPPLY WATER IN AREAS OTHER THAN PARTITIONS. SANITARY & EF SYSTEMS TO BE RE-USED. CREATE OPENING FOR NEW DOORS.





SHEET TITLE

EXISTING THIRD FLOOR PLAN

SHEET#

A-103

JOB #: DATE:









- STRUCTURAL ENGINEER SHALL REVIEW & APPROVE ALL PARTITIONS PRIOR TO COMPLETE DEMOLITION
- ALL EXISTING SANITARY SYSTEMS ARE TO REMAIN
- EXISTING EXTERIOR LIGHTING SYSTEMS DEMOLITION IS LIMITED TO REMOVING FIXTURES. FIXTURES WILL BE REPLACED DURING CONSTRUCTION. THE DESIGN INTENT IS RE-USE OF EXTERIOR LIGHTING WIRING & BOXES
- ALL DOOR SYSTEMS BETWEEN GUESTROOMS ARE TO BE DEMOLISHED COMPLETELY
- SLAB CORE CUTS REQUIRED AT ALL NEW ELEC. PANEL CHASES & SRINKLER RISER
- EXISTING ELEVATOR TO REMAIN
- IF DISCREPANCIES ARE FOUND OR IF ANY DRAWING IS UNCLEAR GC SHALL NOTIFY ARCHITECT AND BE GIVEN DIRECTION OR CLARIFICATION PER THE ORIGINAL DESIGN INTENT BY THE ARCHITECT BEFORE PROCEEDING WITH AFFECTED WORK.

DEMOLITION LEGEND

SELECTIVE DEMOLITION

DEMOLITION: GUESTROOM DEMOLISH COMPLETE INTERIOR

PARTITIONS & DOORS AS INDICATED. SELECTIVE DEMOLITION LIMITED TO REMOVAL OF EXISTING PANEL, P/M/E FIXTURES & FLOOR FINISHES. CAP & ABANDON IN PLACE ELECTRICAL & SUPPLY WATER IN AREAS OTHER THAN PARTITIONS. SANITARY & EF SYSTEMS TO BE RE-USED. CREATE OPENING FOR NEW DOORS.





SHEET TITLE **EXISTING** FOURTH FLOOR

A-104

PLAN

SHEET#

00000.00 DATE: 12.28.2023 **PERMIT SET**



LAND . ARCHITECTURE

FOURTH FLOOR PLAN



EXSTINGTICOL TO REMAIN

GENERAL PLAN NOTES

- STRUCTURAL ENGINEER SHALL
 REVIEW & APPROVE ALL PARTITIONS
 PRIOR TO COMPLETE DEMOLITION
- ALL EXISTING SANITARY SYSTEMS ARE TO REMAIN
- EXISTING EXTERIOR LIGHTING
 SYSTEMS DEMOLITION IS LIMITED TO
 REMOVING FIXTURES. FIXTURES WILL
 BE REPLACED DURING
 CONSTRUCTION. THE DESIGN INTENT
 IS RE-USE OF EXTERIOR LIGHTING
 WIRING & BOXES
- ALL DOOR SYSTEMS BETWEEN
 GUESTROOMS ARE TO BE
 DEMOLISHED COMPLETELY
- SLAB CORE CUTS REQUIRED AT ALL NEW ELEC. PANEL CHASES & SRINKLER RISER
- EXISTING ELEVATOR TO REMAIN
- IF DISCREPANCIES ARE FOUND OR IF ANY DRAWING IS UNCLEAR GC SHALL NOTIFY ARCHITECT AND BE GIVEN DIRECTION OR CLARIFICATION PER THE ORIGINAL DESIGN INTENT BY THE ARCHITECT BEFORE PROCEEDING WITH AFFECTED WORK.

DEMOLITION LEGEND

SELECTIVE DEMOLITION

DEMOLITION: GUESTROOM

DEMOLISH COMPLETE INTERIOR
PARTITIONS & DOORS AS INDICATED.
SELECTIVE DEMOLITION LIMITED TO
REMOVAL OF EXISTING PANEL, P/M/E
FIXTURES & FLOOR FINISHES. CAP &

REMOVAL OF EXISTING PANEL, P/M/E
FIXTURES & FLOOR FINISHES. CAP &
ABANDON IN PLACE ELECTRICAL &
SUPPLY WATER IN AREAS OTHER THAN
PARTITIONS. SANITARY & EF SYSTEMS TO
BE RE-USED. CREATE OPENING FOR
NEW DOORS.

Synchronicity LAND ARCHITECTURE



THE TEALE - GOLDEN GATE PKWY

S H E E T T I T L E

EXISTING ROOF PLAN

S H E E T #

В#:

00000.00 12.28.2023 PERMIT SET

SYNChronicity



PR	OPOSED PLAN NOTE	GENERAL PLAN N
1	NEW UNIT DOOR, REF. A-701 FOR WINDOW SCHEDULE AND DETAIL.	ALL DIMENSIONS ARE TA STUD/BLOCK NEW & F/ W
2	TYP. CORNER KITCHEN, REF. A-111	 IF DISCREPANCIES ARE F ANY DRAWING IS UNCLE
3	TYP. NEW BATHROOM, REF. A-114	NOTIFY ARCHITECT AND DIRECTION OR CLARIFIC ORIGINAL DESIGN INTEN
	NEW BATHROOM DOOR,REF. A-701	ARCHITECT BEFORE PRO

NOTES

- FOR WINDOW SCHEDULE AND DETAIL. REPAIR EXISTING BALCONY GUARD SYSTEM PER 2020 FBC REF. STRUCTURAL
- AKEN FROM F/ WALL EXISTING.
 - FOUND OR IF LEAR GC SHALL D BE GIVEN ICATION PER THE ENT BY THE OCEEDING WITH AFFECTED WORK.
 - GC SHALL FIELD VERIFY ALL DIMS AND EXIST. COND. PRIOR TO CONSTRUCTION



CONSTRUCTION NOTES

- EXISTING BUILDING PROTECTED BY **EXISTING NFPA 13R AUTOMATIC FIRE** SPRINKLER SYSTEM. ALL AREAS RECEIVING ALTERATIONS SHALL BE PROTECTED AS REQUIRED PER FBC 903.3.1.2
- EXISTING 60 MINUTE FIRE SEPARATION SHALL REMAIN BETWEEN ALL R2 UNITS, ACCESSORY USES, AND CORRIDOR WALLS. REPAIR EXISTING MEMBRANES AS REQUIRED
- NEW PLUMBING EQUIPMENT TO REPLACE EXISTING SHALL BE IN THE SAME LOCATION & REUSE EXIST SLAB OPENINGS. BUILDING SANITARY SYSTEM TO BE REUSED
- INTERIOR LIGHT FIXTURES SHALL BE SURFACE MOUNTED.

LEGEND

(C)	WINDOW TAG - REFER TO SHEET A-701

1102) DOOR TAG - REFER TO SHEET A-701

WALL TAG -

RATED WALL

RATED WALL ASSEMBLY

WALL TYPE LEGEND

USE MOISTURE/MOLD RESISTANT GWB & PT WOOD OR GALV. LG. STL. FRAMING AT ALL WET OR UNCOND. LOCATIONS, TYP.

(1) LAYER TYPE X GWB ON 2X4 STUD STAGGERED 8" O.C. W/ 3-1/2" BATT IN CAVITY & (1) LAYER TYPE X 5/8" GWB OTHER SIDE - MATCH EXISTING WALL THICKNESS. MIN. 30 MIN. FIRE RATED WALL.

(1) LAYER GWB EACH SIDE ON 2X4 STUD 16" O.C.

(1) LAYER TYPE X GWB ON 2X4 STUD STAGGERED 8" O.C. W/ 3-1/2" BATT IN CAVITY & (1) LAYER TYPE X 5/8" GWB EACH SIDE - MATCH EXISTING WALL THICKNESS. MIN. 1 HOUR FIRE RATED WALL.

FILL EXISTING OPENING TO MATCH

EXISTING EXTERIOR WALL



PRO.

UNIT A

139

115

138

R. UNIT

PRO.

UNIT A

PRO.

UNIT B

137

136

R. UNIT

PRO.

UNIT B

30,8 NM SWK

PRO.

UNIT A

133

132

R. UNIT

UNIT A

PRO.

UNIT A

135

134

R. UNIT

PRO.

UNIT A

PRO.

UNIT B

131

R. UNIT

130

R. UNIT

PRO.

UNIT B

PRO.

UNIT C

129 R. UNIT

101

HEQ. STORAGE

128

R. UNIT

PRO.

UNIT A

PRO.

UNIT A

149

24 CVB BZS 100 CVB BZ 100 CVB

129

148

R. UNIT

PRO.

UNIT A

PRO.

UNIT B

147

R. UNIT

146

R. UNIT

PRO.

UNIT B

PRO.

UNIT A

145

144

R. UNIT

PRO.

UNIT A

PRO.

UNIT A

143

142

R. UNIT

PRO.

UNIT A

PRO.

UNIT B

141

140

R. UNIT

PRO.

UNIT B

EQ. UNIT

103

EQ. UNIT



SHEET TITLE

PROPOSED FIRST FLOOR PLAN

SHEET #

A-106

JOB #: 00000.00 DATE:

RE:

12.28.2023 **PERMIT SET**



PR	OPOSED PLAN NOTE	GENERAL PLAN NOTES
1	NEW UNIT DOOR, REF. A-701 FOR WINDOW SCHEDULE AND DETAIL.	ALL DIMENSIONS ARE TAKEN FROM F/ STUD/BLOCK NEW & F/ WALL EXISTING.
2	TYP. CORNER KITCHEN, REF. A-111	IF DISCREPANCIES ARE FOUND OR IF ANY DRAWING IS UNCLEAR GC SHALL
3	TYP. NEW BATHROOM, REF. A-114	NOTIFY ARCHITECT AND BE GIVEN DIRECTION OR CLARIFICATION PER THE ORIGINAL DESIGN INTENT BY THE

NEW BATHROOM DOOR, REF. A-701

REPAIR EXISTING BALCONY GUARD SYSTEM PER 2020 FBC REF. STRUCTURAL

FOR WINDOW SCHEDULE AND DETAIL.





CONSTRUCTION NOTES

ORIGINAL DESIGN INTENT BY THE

AFFECTED WORK.

ARCHITECT BEFORE PROCEEDING WITH

GC SHALL FIELD VERIFY ALL DIMS AND

EXIST. COND. PRIOR TO CONSTRUCTION

- EXISTING BUILDING PROTECTED BY **EXISTING NFPA 13R AUTOMATIC FIRE** SPRINKLER SYSTEM. ALL AREAS RECEIVING ALTERATIONS SHALL BE PROTECTED AS REQUIRED PER FBC 903.3.1.2
- EXISTING 60 MINUTE FIRE SEPARATION SHALL REMAIN BETWEEN ALL R2 UNITS, ACCESSORY USES, AND CORRIDOR WALLS. REPAIR EXISTING MEMBRANES AS REQUIRED
- NEW PLUMBING EQUIPMENT TO REPLACE EXISTING SHALL BE IN THE SAME LOCATION & REUSE EXIST SLAB OPENINGS. BUILDING SANITARY SYSTEM TO BE REUSED
- INTERIOR LIGHT FIXTURES SHALL BE SURFACE MOUNTED.

	LEC	GEND
	(C)	WINDOW TAG - REFER TO SHEET A-70°
	(1102)	DOOR TAG - REFER TO SHEET A-701
	(A)	WALL TAG -

RATED WALL

RATED WALL ASSEMBLY

WALL TYPE LEGEND


USE MOISTURE/MOLD RESISTANT GWB & PT WOOD OR GALV. LG. STL. FRAMING AT ALL WET OR UNCOND. LOCATIONS, TYP.

	\langle	(1) LAYER TYPE X GWB ON 2X4 STUD STAGGERED 8" O.C. W/ 3-1/2" BATT IN CAVITY & (1) LAYER TYPE X 5/8" GWB OTHER SIDE - MATCH EXISTING WALL THICKNESS. MIN. 30 MIN. FIRE RATED WALL.
--	----------------	--

(1) LAYER GWB EACH SIDE ON 2X4 STU 16" O.C.		
	⟨B⟩	(1) LAYER GWB EACH SIDE ON 2X4 STU 16" O.C.
	\/	

\limits	(1) LAYER TYPE X GWB ON 2X4 STUD STAGGERED 8" O.C. W/ 3-1/2" BATT IN CAVITY & (1) LAYER TYPE X 5/8" GWB EACH SIDE - MATCH EXISTING WALL THICKNESS. MIN. 1 HOUR FIRE RATED WALL.	

FILL EXISTING OPENING TO MATCH
EXISTING EXTERIOR WALL

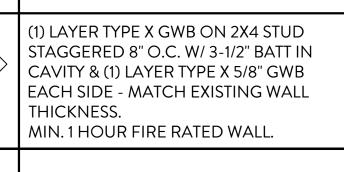



SHEET TITLE

PROPOSED


SECOND FLOOR

PLAN

SHEET#

JOB#: 00000.00 12.28.2023 DATE: RE: **PERMIT SET**



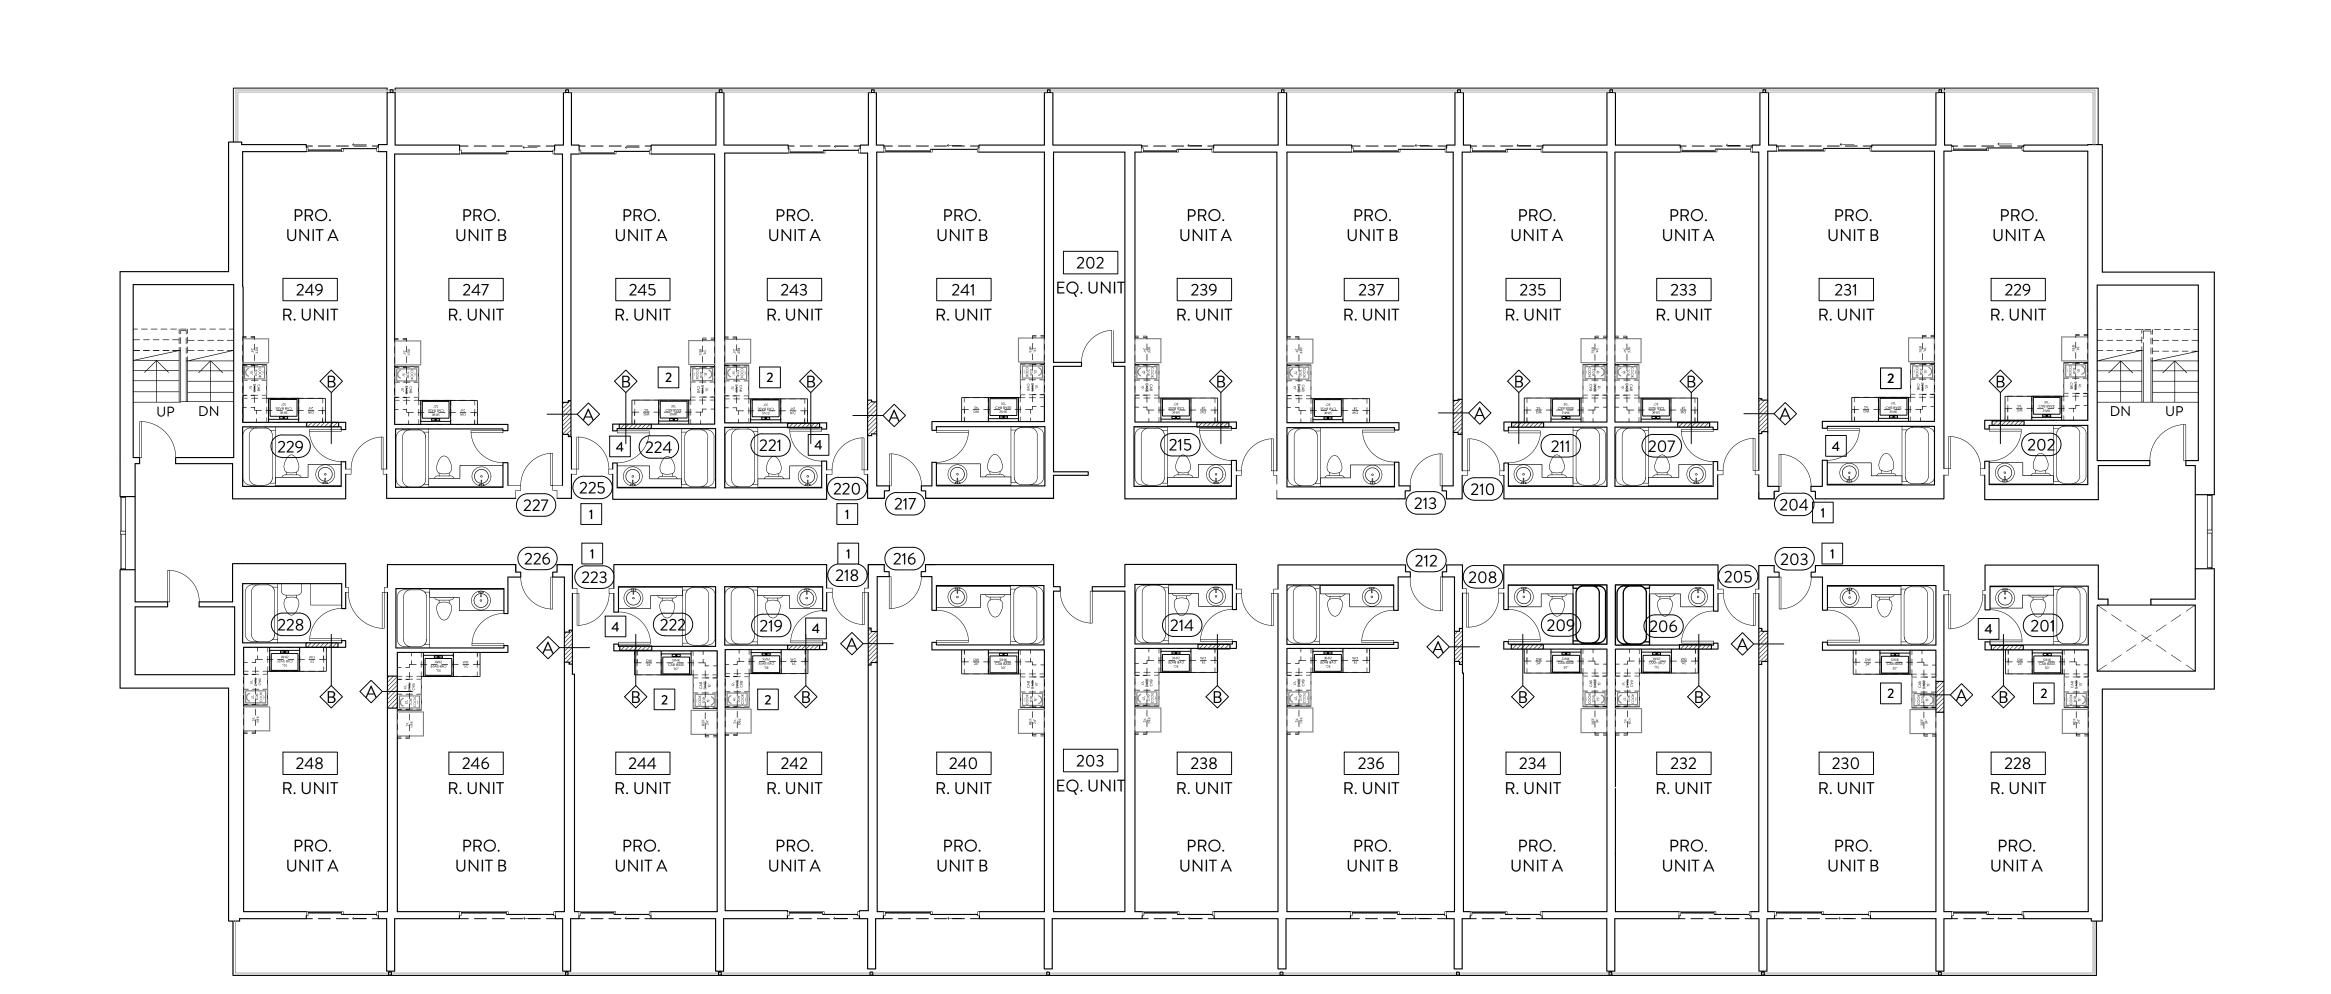

SECOND FLOOR PLAN SCALE: 1/8"=1'-0" @ 24"x36" OR 1/16"=1'-0" @ 12"X18"



PR	OPOSED PLAN NOTE	GENERAL PLAN NOTES		
1	NEW UNIT DOOR, REF. A-701 FOR WINDOW SCHEDULE AND DETAIL.	ALL DIMENSIONS ARE TAKEN FROM F/ STUD/BLOCK NEW & F/ WALL EXISTING.		
2	TYP. CORNER KITCHEN, REF. A-111	IF DISCREPANCIES ARE FOUND OR IF ANY DRAWING IS UNCLEAR GC SHALL		
3	TYP. NEW BATHROOM, REF. A-114	NOTIFY ARCHITECT AND BE GIVEN DIRECTION OR CLARIFICATION PER THE ORIGINAL DESIGN INTENT BY THE		
	NEW BATHROOM DOOR,REF. A-701	ARCHITECT BEFORE PROCEEDING WITH		

REPAIR EXISTING BALCONY GUARD SYSTEM PER 2020 FBC REF. STRUCTURAL

FOR WINDOW SCHEDULE AND DETAIL.





CONSTRUCTION NOTES

GC SHALL FIELD VERIFY ALL DIMS AND

EXIST. COND. PRIOR TO CONSTRUCTION

AFFECTED WORK.

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- INTERIOR LIGHT FIXTURES SHALL BE SURFACE MOUNTED.

	LEC	GEND
	(C)	WINDOW TAG - REFER TO SHEET A-70
	(1102)	DOOR TAG - REFER TO SHEET A-701
		WALL TAG -

RATED WALL

RATED WALL ASSEMBLY

WALL TYPE LEGEND

USE MOISTURE/MOLD RESISTANT GWB & PT WOOD OR GALV. LG. STL. FRAMING AT ALL WET OR UNCOND. LOCATIONS, TYP.

	\langle	(1) LAYER TYPE X GWB ON 2X4 STUD STAGGERED 8" O.C. W/ 3-1/2" BATT IN CAVITY & (1) LAYER TYPE X 5/8" GWB OTHER SIDE - MATCH EXISTING WAL THICKNESS. MIN. 30 MIN. FIRE RATED WALL.
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⟨B⟩	10 0.6.

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FILL EXISTING OPENING TO MATC
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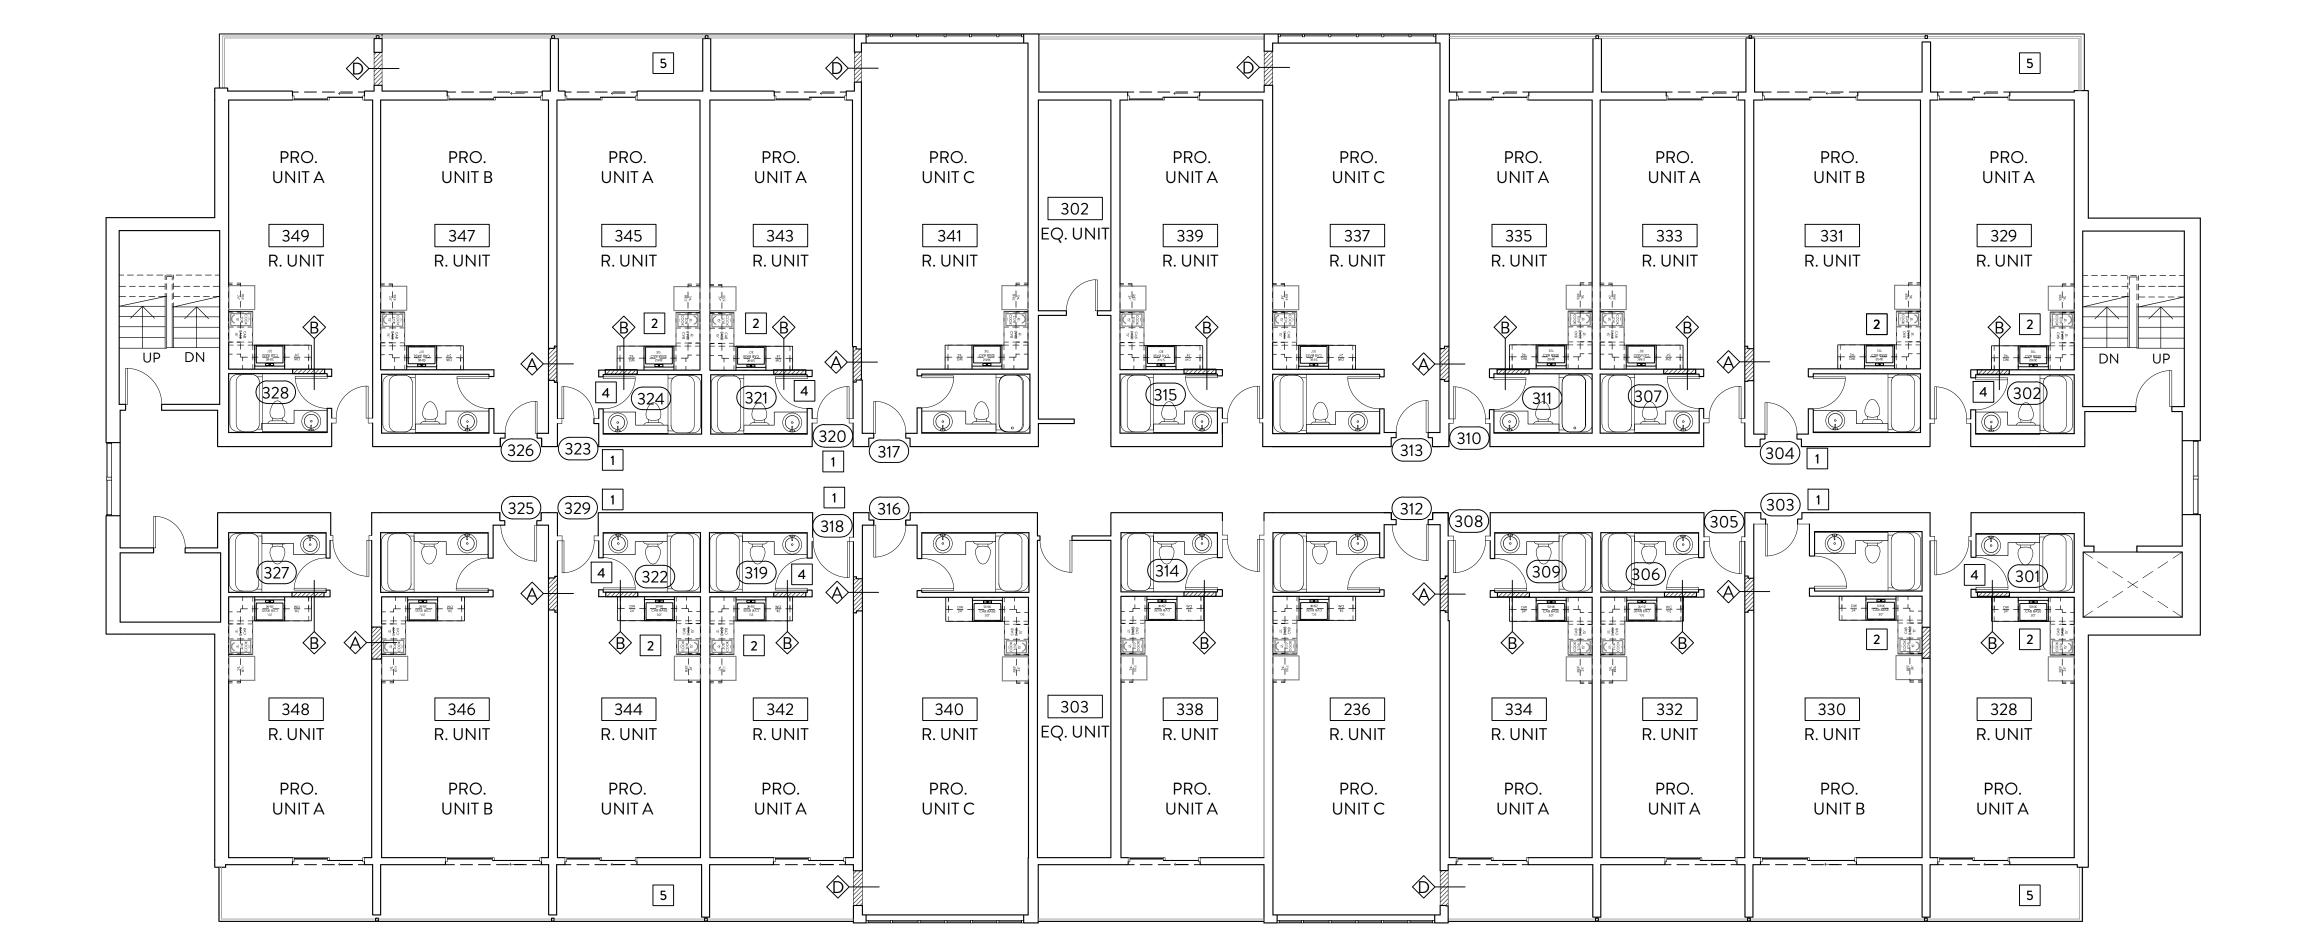


SHEET TITLE

A-108

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JOB#: 12.28.2023 DATE: RE: **PERMIT SET**









PR	OPOSED PLAN NOTE	GENERAL PLAN NOTES				
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NEW BATHROOM DOOR, REF. A-701

REPAIR EXISTING BALCONY GUARD

FOR WINDOW SCHEDULE AND DETAIL.

SYSTEM PER 2020 FBC REF. STRUCTURAL





CONSTRUCTION NOTES

ORIGINAL DESIGN INTENT BY THE

AFFECTED WORK.

ARCHITECT BEFORE PROCEEDING WITH

GC SHALL FIELD VERIFY ALL DIMS AND

EXIST. COND. PRIOR TO CONSTRUCTION

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	LEGEND						
	©	WINDOW TAG - REFER TO SHEET A-70					
	(1102)	DOOR TAG - REFER TO SHEET A-701					
	\Diamond	WALL TAG -					

RATED WALL

RATED WALL ASSEMBLY


WALL TYPE LEGEND

USE MOISTURE/MOLD RESISTANT GWB & PT WOOD OR GALV. LG. STL. FRAMING AT ALL WET OR UNCOND. LOCATIONS, TYP.


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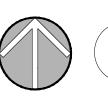
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FOURTH FLOOR PLAN SCALE: 1/8"=1'-0" @ 24"x36" OR 1/16"=1'-0" @ 12"X18"




SHEET TITLE PROPOSED FOURTH FLOOR PLAN

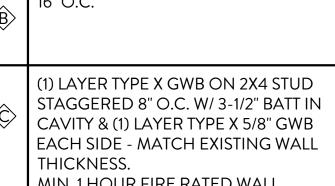SHEET#

RE:

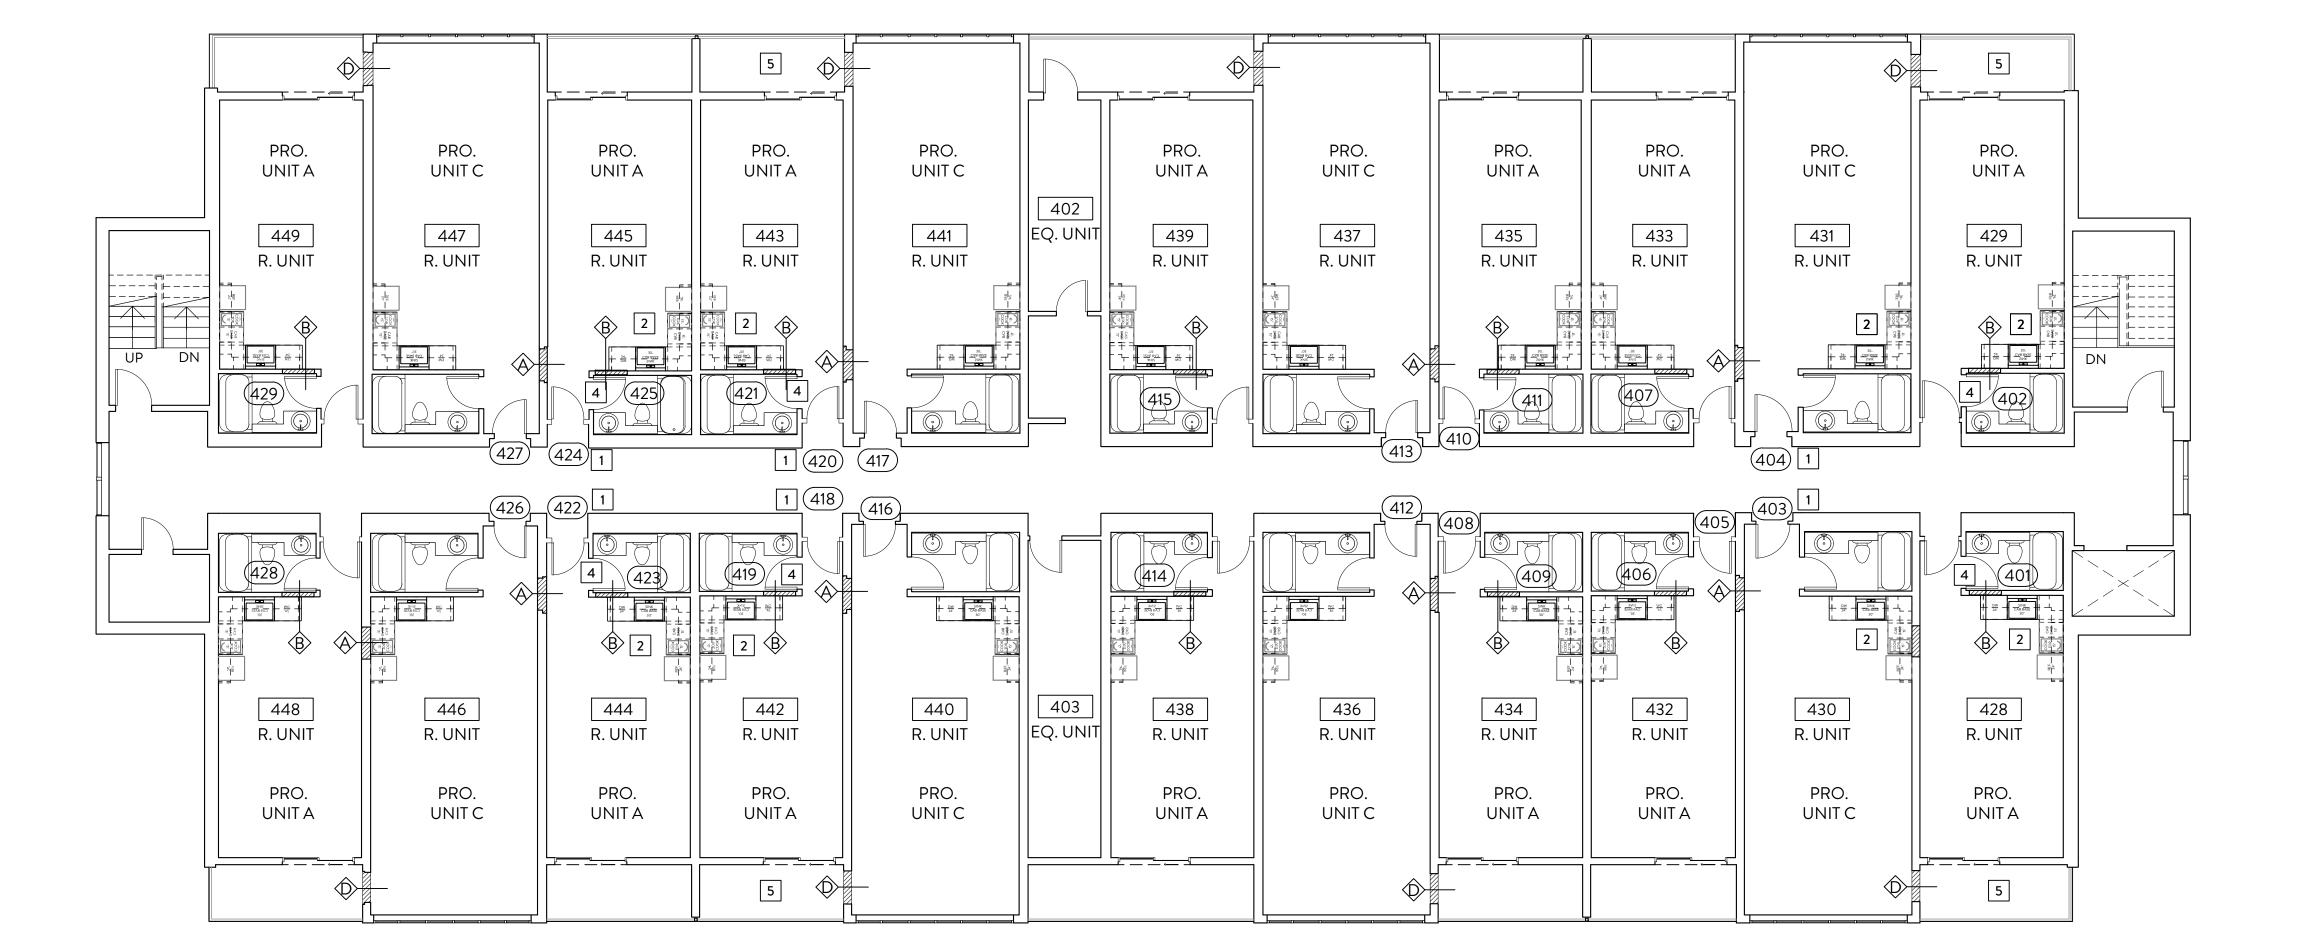A-109 JOB #: 00000.00 DATE: 12.28.2023

PERMIT SET

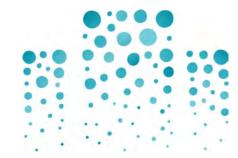

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GENERAL PLAN NOTES

- ALL DIMENSIONS ARE TAKEN FROM F/ STUD/BLOCK NEW & F/ WALL EXISTING.
- IF DISCREPANCIES ARE FOUND OR IF ANY DRAWING IS UNCLEAR GC SHALL NOTIFY ARCHITECT AND BE GIVEN DIRECTION OR CLARIFICATION PER THE ORIGINAL DESIGN INTENT BY THE ARCHITECT BEFORE PROCEEDING WITH AFFECTED WORK.
- GC SHALL FIELD VERIFY ALL DIMS AND EXIST. COND. PRIOR TO CONSTRUCTION





CONSTRUCTION NOTES

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- INTERIOR LIGHT FIXTURES SHALL BE SURFACE MOUNTED.

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SHEET TITLE

PROPOSED ROOF PLAN

A-110


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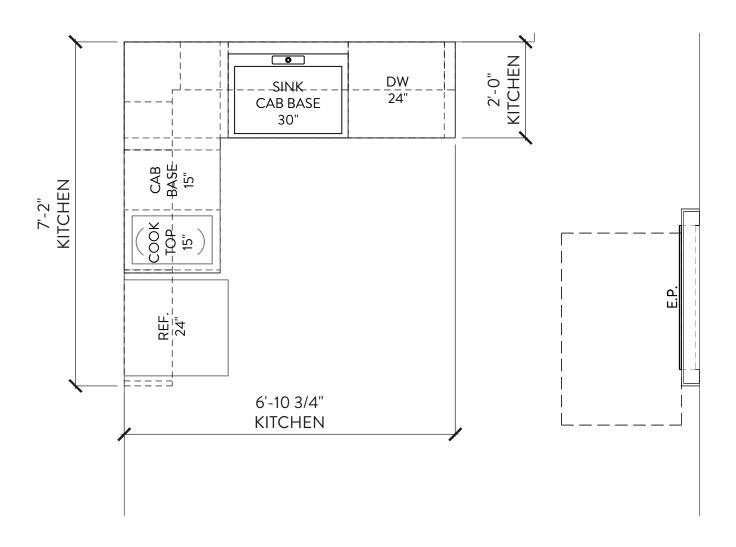
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Synchronicity








3 TYP. NEW BATHROOM ENLARGED PLAN SCALE: 1/2"=1'-0" @ 24"x36" OR 1/8"=1'-0" @ 12"X18"

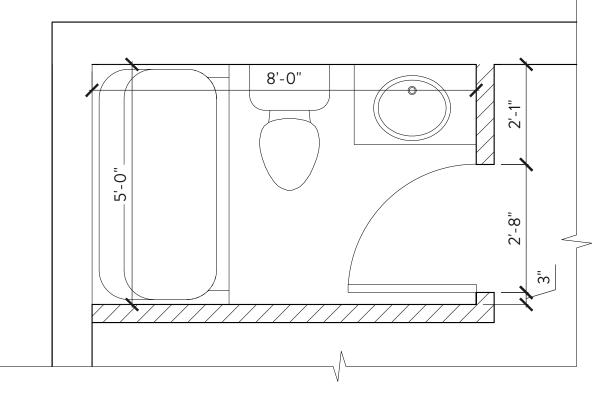

2 TYP. CORNER KITCHEN ENLARGED PLAN SCALE: 1/2"=1'-0" @ 24"x36" OR 1/8"=1'-0" @ 12"X18"

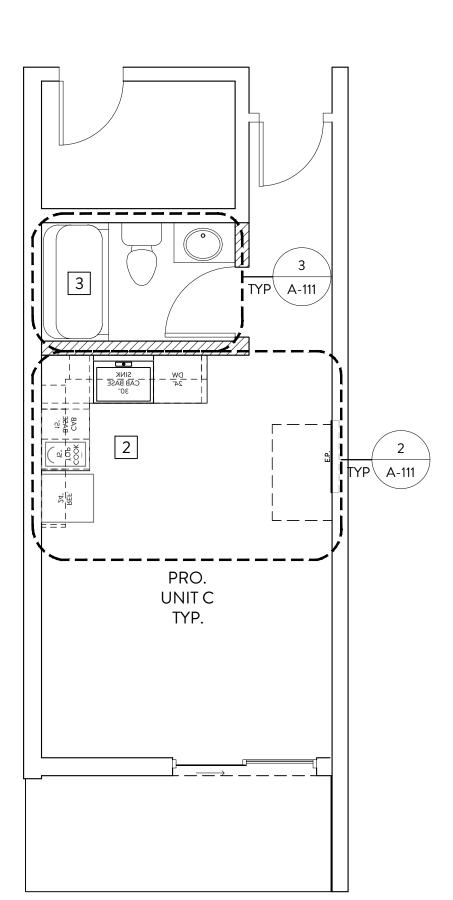

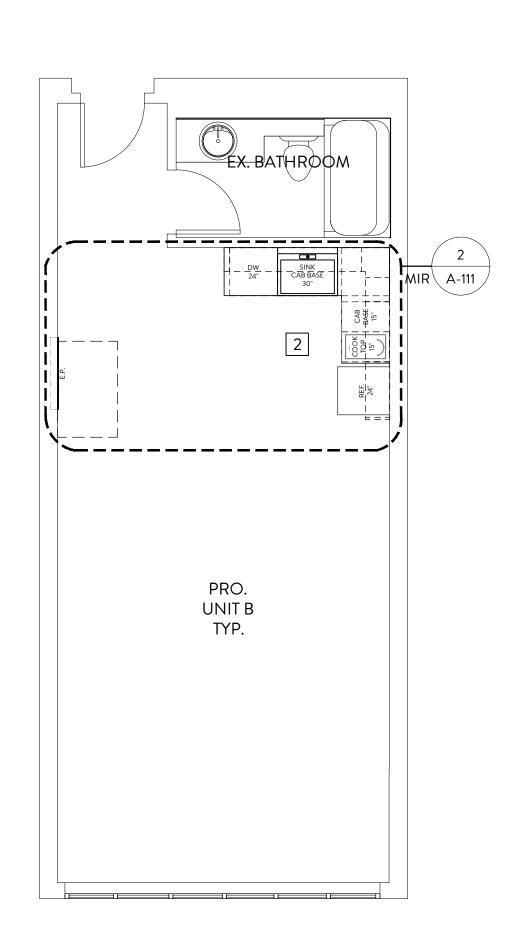

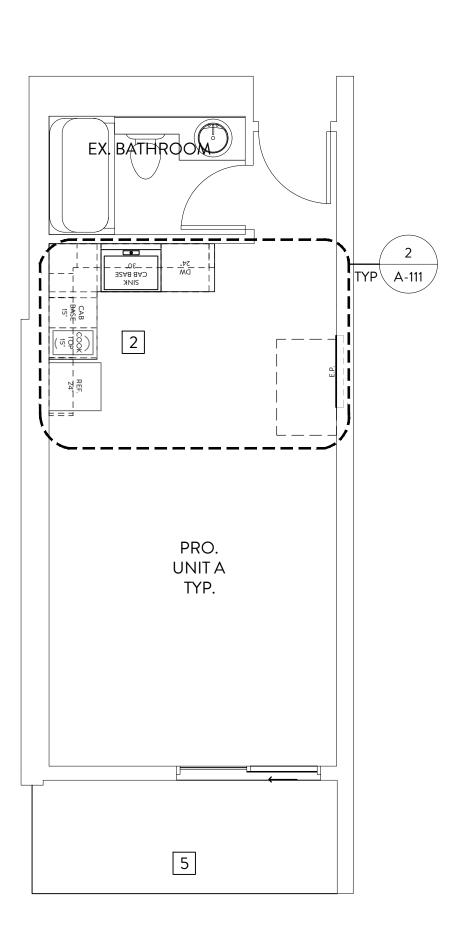



Synchronicity

TYP. KITCHEN PLAN NOTE GENERAL PLAN NOTES

THE DESIGN INTENT IS TO REUSE ALL EXISTING PARTITIONS UNLESS OTHERWISE NOTED. GC TO FIELD VERIFY ALL EXISTING CONDITIONS PRIOR TO COMMENCEMENT OF CONSTRUCTION. GC SHALL NOTIFY ARCHITECT & OWNER OF DISCREPANCIES ARE DISCOVERED.

- ALL DIMENSIONS ARE TAKEN FROM F/ STUD/BLOCK NEW & F/ WALL EXISTING.
- IF DISCREPANCIES ARE FOUND OR IF ANY DRAWING IS UNCLEAR GC SHALL NOTIFY ARCHITECT AND BE GIVEN DIRECTION OR CLARIFICATION PER THE ORIGINAL DESIGN INTENT BY THE ARCHITECT BEFORE PROCEEDING WITH AFFECTED WORK.
- GC SHALL FIELD VERIFY ALL DIMS AND EXIST. COND. PRIOR TO CONSTRUCTION

ELECTRICAL PANEL NOTE | CONSTRUCTION NOTES

ALL R-2 UNIT ELECTRICAL PANELS SHALL BE STACKED 1ST & 2ND FLOORS. PENETRATE 2ND FLOOR CEILING BEHIND PANEL INSIDE FURRING AND SLAB BETWEEN 1ST & 2ND FLOORS. PENETRATION SIZED FOR MINIMUM OPENING, AFTER INSTALLATION FILL ANY GAPS WITH FIRE SEALANT.

PROPOSED PLAN NOTE

- NEW UNIT DOOR, REF. A-701 FOR WINDOW SCHEDULE AND DETAIL.

 TYP. CORNER KITCHEN, REF. A-111
- TYP. NEW BATHROOM, REF. A-114
- NEW BATHROOM DOOR,REF. A-701 FOR WINDOW SCHEDULE AND DETAIL.
- REPAIR EXISTING BALCONY GUARD SYSTEM PER 2020 FBC REF. STRUCTURAL

 EXISTING BUILDING PROTECTED BY EXISTING NFPA 13R AUTOMATIC FIRE SPRINKLER SYSTEM. ALL AREAS RECEIVING ALTERATIONS SHALL BE PROTECTED AS REQUIRED PER FBC

903.3.1.2

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LEGEND

© WINDOW TAG - REFER TO SHEET A-701

(1102) DOOR TAG - REFER TO SHEET A-701

WALL TAG -

RATED WALL

RATED WALL ASSEMBLY

WALL TYPE LEGEND

USE MOISTURE/MOLD RESISTANT GWB & PT WOOD OR GALV. LG. STL. FRAMING AT ALL WET OR UNCOND. LOCATIONS, TYP.


(1) LAYER TYPE X GWB ON 2X4 STUD STAGGERED 8" O.C. W/ 3-1/2" BATT IN CAVITY & (1) LAYER TYPE X 5/8" GWB OTHER SIDE - MATCH EXISTING WALL THICKNESS.
MIN. 30 MIN. FIRE RATED WALL.

(1) LAYER GWB EACH SIDE ON 2X4 STUD 16" O.C.

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MIN. 1 HOUR FIRE RATED WALL.

FILL EXISTING OPENING TO MATCH EXISTING EXTERIOR WALL



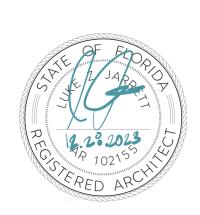

HEALE - G

TYPICAL

R. UNIT TYPES

s H E E T #


A-111


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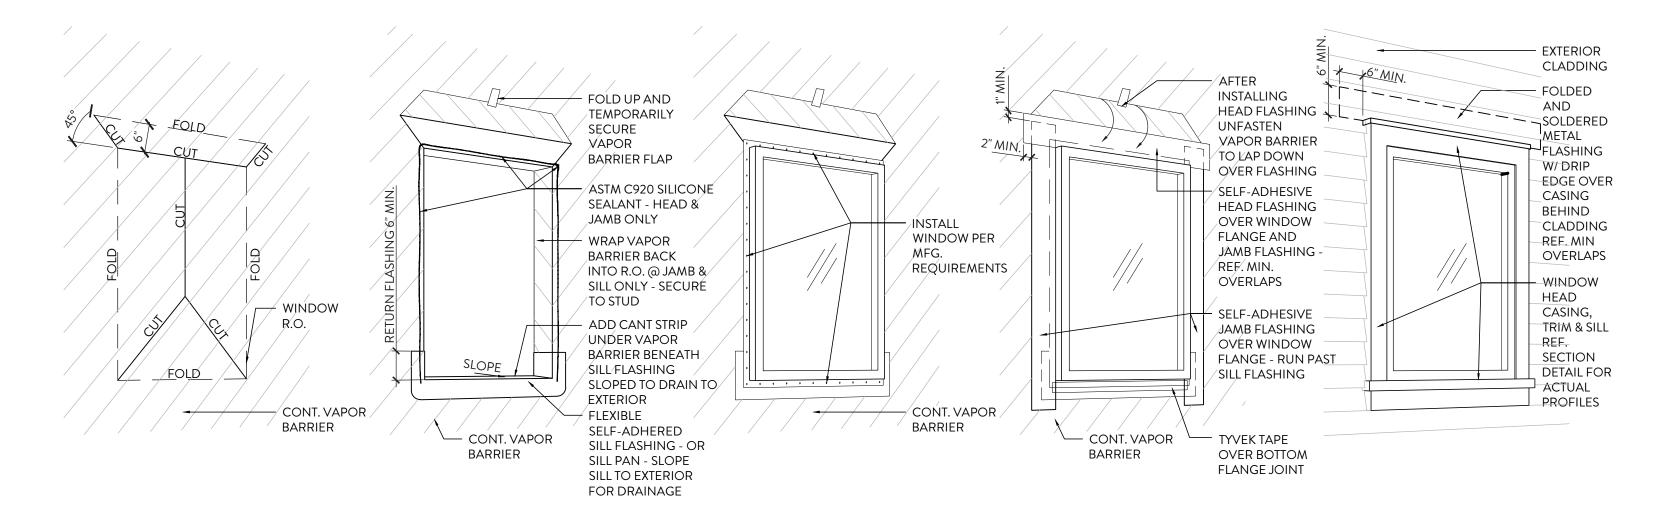
12.28.2023 PERMIT SET

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4 PRE-HUNG EXTERIOR DOOR FLASHING DETAIL SCALE: NTS




INTEGRAL FIN WINDOW FLASHING DETAIL 3 INTEGRA

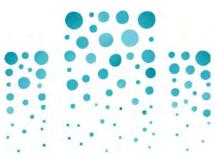


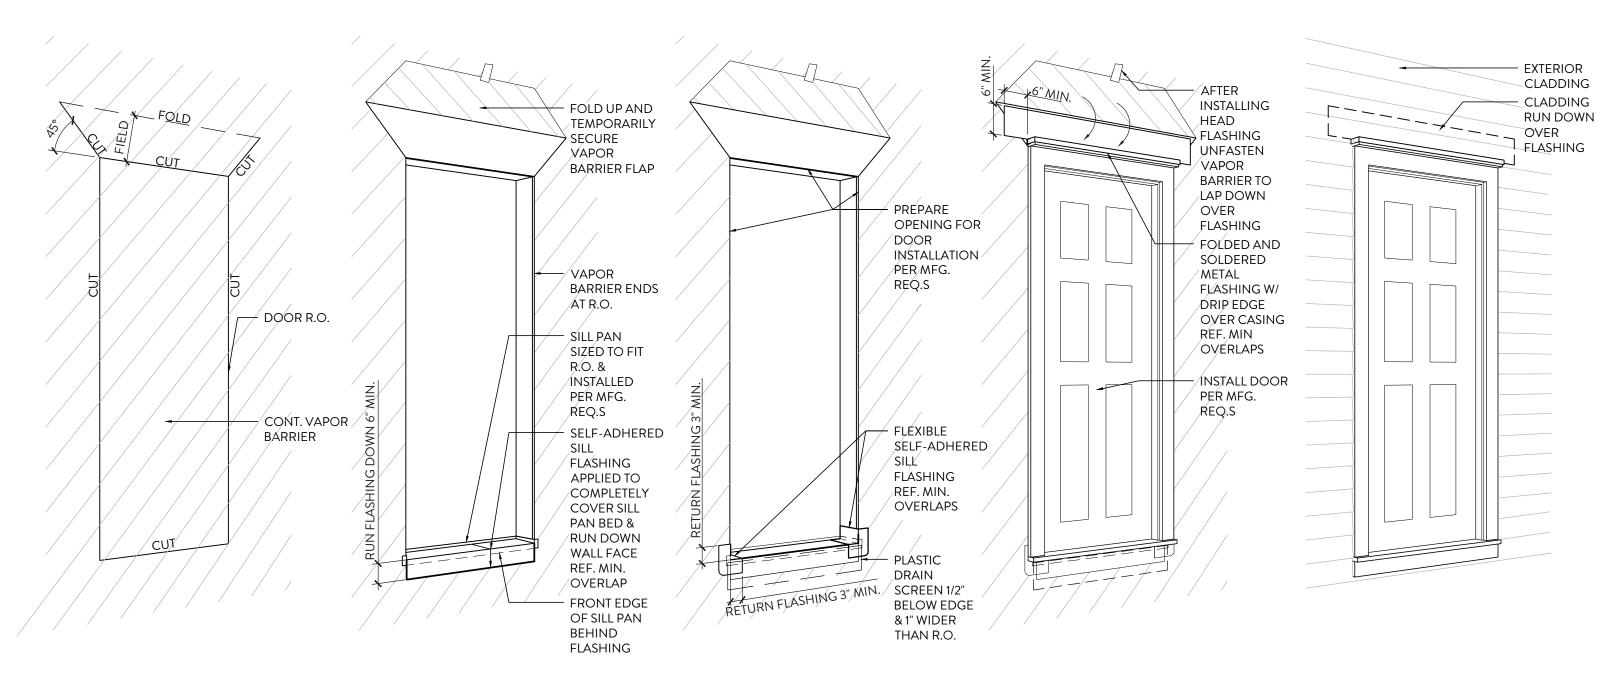DOOR SCHEDULE - BUILDING A											
	DOOR						FRAME		FIRE		55111516
TAG	DOOR SIZE	INT/EXT	HDR	TYPE	MATL	GLAZ	TYPE	MATL	RATING	HDW	REMARKS
101 103 105 107 109 111 114 115 119 121 123 125 128 129	2'-8" X 6'-8"	INT	6'-8"		WOOD	NA		WOOD	NR	#2	NEW UNIT BATHROOM DOOR
102 104 106 108 110 112 113 116 117 118 120 122 124 126 127	2'-8" X 6'-8"	INT	6'-8"		MTL	NA		MTL	45 MIN	#1	NEW UNIT DOOR
201 202 206 207 209 211 214 215 219 221 222 224 229 228	2'-8" X 6'-8"	INT	6'-8"		WOOD	NA		WOOD	NR	#2	NEW UNIT BATHROOM DOOR
203 (204 (205 (208) 210 (212 (213 (216) 217 (218 (220 (223) 225 (226 (227)	2'-8" X 6'-8"	INT	6'-8"		MTL	NA		MTL	45 MIN	#1	NEW UNIT DOOR
301 302 306 307 309 311 314 315 319 321 322 324 327 328	2'-8" X 6'-8"	INT	6'-8"		WOOD	NA		WOOD	NR	#2	NEW UNIT BATHROOM DOOR
303 304 305 308 310 312 313 316 317 318 320 323 325 326	2'-8" X 6'-8"	INT	6'-8"		MTL	NA		MTL	45 MIN	#1	NEW UNIT DOOR
401 402 406 407 409 411 414 415 419 421 423 425 428 429	2'-8" X 6'-8"	INT	6'-8"		WOOD	NA		WOOD	NR	#2	NEW UNIT BATHROOM DOOR
403 404 405 408 410 412 413 416 417 418 420 422 424 426 427	2'-8" X 6'-8"	INT	6'-8"		MTL	NA		MTL	45 MIN	#1	NEW UNIT DOOR

- EXISTING DOORS TO REMAIN IN ALL LOCATIONS WHERE LAYOUTS REMAIN UNCHANGED
- ALL EXTERIOR GLAZING TO BE USED IN THIS PROJECT SHALL COMPLY WITH ASTM E1996 STANDARD SPECIFICATION FOR PERFORMANCE OF EXTERIOR WINDOWS, CURTAIN WALLS, DOORS, AND IMPACT PROTECTIVE SYSTEMS IMPACTED BY WINDBORNE DEBRIS IN
- HURRICANES WIND ZONE 4 ALL DOOR GLAZING SHALL BE IMPACT RESISTANT OR TEMPERED
- GC FIELD VERIFY EXISTING CEILING/OPENING HEIGHTS FOR ALL DOORS IN EXISTING CONSTRUCTION
- EXISTING DOORS TO REMAIN WHERE LAYOUT REMAINS UNCHANGED.

		DOOR HARDWARE		
SET #1 (R2-EXTERIOR)	SET # 2 (R-2 BATH)	SET # 3 (SLIDING CLT.)	SET # 4 (MAINTENCE /STO)	SET # 5
 ACCESSIBLE HAND-SET DEADBOLT - EXT. MECH. CLOSER WIDE ANGLE VIEWER CHAIN DOOR GUARD EVACUATION MAP FRAME KEYCARD EGRESS 	 ACCESSIBLE HAND-SET PRIVACY LOCKSET 	BI-PASS SLIDING CLOSET DOOR TRACK KIT RECESSED SLIDING CLOSET DOOR PULL SET	 ACCESSIBLE HAND-SET DEADBOLT MECH. CLOSER KICK-PLATE EA. SIDE 	 ACCESSIBLE VERTICAL PULL PUSH PLATE MECH. CLOSER
SET # 6 (FITNESS/ OFFICE)	SET # 7 (EGRESS)	SET # 8 (R-2 BALCONY)		
 ACCESSIBLE HANDLE-SET DEADBOLT-KEY EXT/INT MECH. CLOSER KEYCARD 	 PANIC INT. ACCESSIBLE HANDLE-SET EXT. DEADBOLT MECH. CLOSER KEYCARD EGRESS 	DEADBOLT - EXIT. RECESSED SLIDING BALCONY DOOR PULL SET		

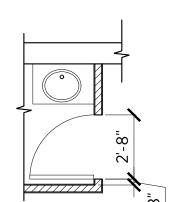

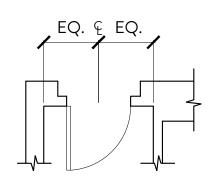

2 NEW BATHROOM DOOR DETAIL SCALE: NTS







SHEET TITLE WINDOW, DOOR & FINISH **SCHEDULES**

A-701

S H E E T #

JOB #: 00000.00 DATE: RE:

12.28.2023 **PERMIT SET**